

Infrastructure Directorate

APPENDICES

Item 12.4.1 - 12.4.3

ORDINARY COUNCIL MEETING

To Be Held

Wednesday, 19th November 2025 Commencing at 5.00pm

Αt

Shire of Dardanup
ADMINISTRATION CENTRE EATON
1 Council Drive - EATON

RISK ASSESSMENT TOOL

OVERALL RISK EVENT: Determine Tender Exempt QUO-F0418808 Burekup Changerooms

RISK THEME PROFILE:


4 - Document Management Processes

15 - Purchasing and Supply

RISK ASSESSMENT CONTEXT: Strategic

			EATMENT OR CO	ONTROL		AFTER TREATEMENT OR CONTROL		
CONSEQUENCE CATEGORY	RISK EVENT	CONSEQUENCE	LIKELIHOOD	INHERENT RISK RATING	RISK ACTION PLAN (Treatment or controls proposed)	CONSEQUENCE	LIKELIHOOD	RESIDUAL RISK RATING
HEALTH	No risk event identified for this category.	Not Required - No Risk Identified	N/A	N/A	Not required	Not required.	Not required.	Not required.
FINANCIAL IMPACT	Overall project cost exceeds budget.	Moderate (3)	Unlikely (2)	Moderate (5 - 11)	Not required	Not required.	Not required.	Not required.
SERVICE INTERRUPTION	No risk event identified for this category.	Not Required - No Risk Identified	N/A	N/A	Not required.	Not required.	Not required.	Not required.
LEGAL AND COMPLIANCE	Failure to adhere to the Act and Regulations in terms of the correct process to run a public Tender	Moderate (3)	Unlikely (2)	Moderate (5 - 11)	Not required.	Not required.	Not required.	Not required.
REPUTATIONAL	Council could be seen in a negative light.	Moderate (3)	Unlikely (2)	Moderate (5 - 11)	Not required.	Not required.	Not required.	Not required.
ENVIRONMENT	No risk event identified for this category.	Not Required - No Risk Identified	N/A	N/A	Not required.	Not required.	Not required.	Not required.
PROPERTY	No risk event identified for this category.	Not Required - No Risk Identified	N/A	N/A	Not required.	Not required.	Not required.	Not required.



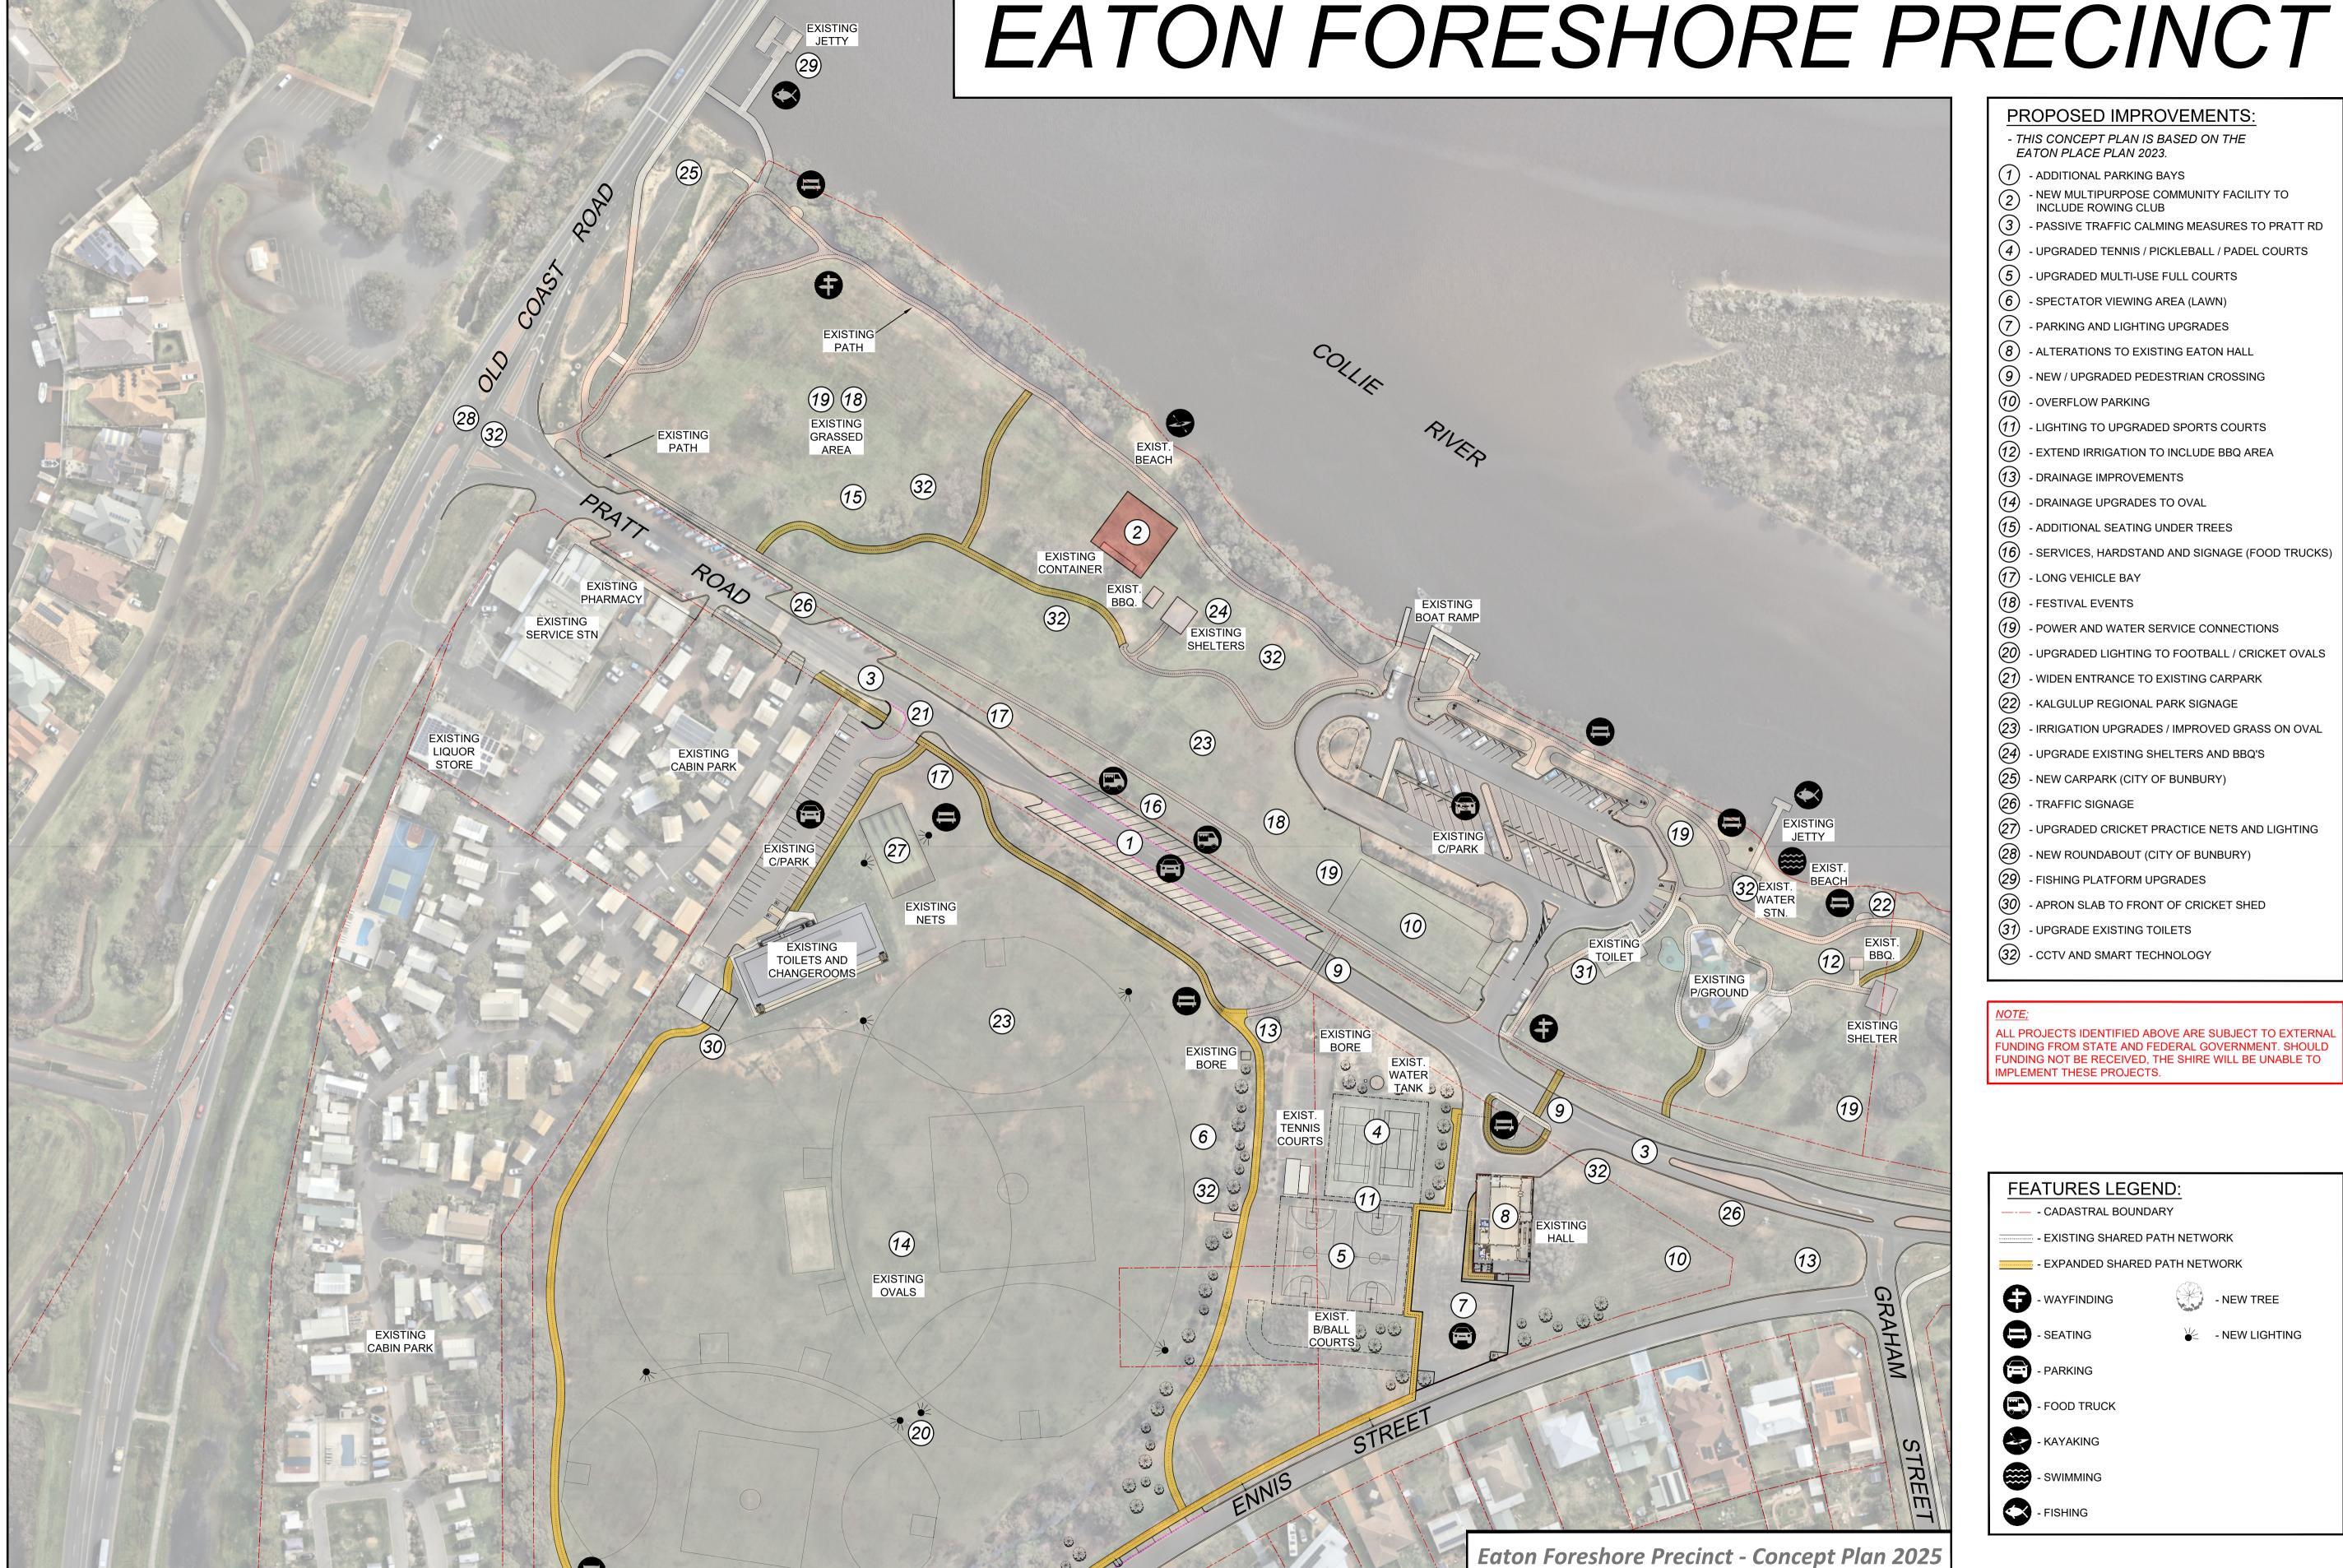

13

DESIGNED

BB

DRAWN

BB

DRAWN DATE

18.08.2025

AUTHORISED

NR

DRAWING NO.

2024-CPT-110-01

C.R. 168-25 O.C.M. 25.06.2025



RISK ASSESSMENT TOOL

OVERALL RISK EVENT: Kalgulup Regional Park – Interpretative Signs Location

RISK THEME PROFILE:

13 - Project Management

Choose an item.

10 - Management of Facilities, Venues, Events and Services

Choose an item.

RISK ASSESSMENT CONTEXT: Op

Operational

CONSEQUENCE		PRIOR TO T	REATMENT OR	CONTROL	RISK ACTION PLAN	AFTER TRE	AFTER TREATEMENT OR CONTRO	
CATEGORY	RISK EVENT	CONSEQUENCE	LIKELIHOOD	INHERENT RISK RATING	(Treatment or controls proposed)	CONSEQUENCE	LIKELIHOOD	RESIDUAL RISK RATING
HEALTH	No risk event identified for this category.	Not Required - No Risk Identified	N/A	N/A	Not required.	Not required.	Not required.	Not required.
FINANCIAL IMPACT	No risk event identified for this category.	Not Required - No Risk Identified	N/A	N/A	Not required.	Not required.	Not required.	Not required.
SERVICE INTERRUPTION	No risk event identified for this category.	Not Required - No Risk Identified	N/A	N/A	Not required.	Not required.	Not required.	Not required.
LEGAL AND COMPLIANCE	No risk event identified for this category.	Not Required - No Risk Identified	N/A	N/A	Not required.	Not required.	Not required.	Not required.
REPUTATIONAL	Possible negative feedback from the community if an inappropriate location is chosen for the signs.	Minor (2)	Possible (3)	Moderate (5 - 11)	Select a location that will achieve the objectives of the signs and not negatively impact on the public open space.	Minor (2)	Unlikely (2)	Low (1 - 4)
ENVIRONMENT	No risk event identified for this category.	Not Required - No Risk Identified	N/A	N/A	Not required.	Not required.	Not required.	Not required.
PROPERTY	No risk event identified for this category.	Not Required - No Risk Identified	N/A	N/A	Not required.	Not required.	Not required.	Not required.


Kalgulup Regional Park Interpretive Signage Inventory (North to South) - August 2025

Location	Size	Sign Heading	Sign Design and PDF/DBCA Job Name
Brunswick River	1600 x 590	A magic thing	A five seems among rhing. A near seems among
Leicester Reserve	1800 x 1200	Welcome to Kalgulup Regional Park Place of fire (Duplicate)	Welcome to Kalgulup Regional Pork Happan Faster of white word from the company and the compan
Leicester Reserve	1800 x 1200	Leicester Reserve A place to reflect	Leicester Reserve Application to reflect According without The control of the

Eaton Foreshore	1800 x 1200	Welcome to Kalgulup Regional Park Place of fire	Welcome to Kalgulup Regional Park Higher fragment his and of most disparticular would from humble and particular and the format humble and particular and particular and the format humble and particular
Eaton Foreshore	1800 x 1200	Eaton Foreshore A meeting place	Reservations on many period and management of the control of the c
Mangrove Cove	1800 x 1200	Welcome to Kalgulup Regional Park Place of fire (Duplicate)	Welcome to Kalgulup Regional Park High parametria via or found injury or found or found to those boards The state of the company of the com

Mangrove Cove	1800 x 1200	Mangrove Cove Going with the flow	Fundamental control between the control between the control of the
Mangrove Cove	1600 x 450	3 signs mounted on the railing Mangrove mysteries Dynamic mangroves Sedges and samphire	**Bandard State (Control of State St
Mangrove Cove	1600 x 590	Fishing master	Fishing moster Any or with the first will be selected the control of the control
Kaeshagen Wetland	1600 x 590	Kaeshagen wetland Kalgulup Regional Park	Kalgulup Regional Park Foreign research Foreign for research Fo

Maidens Reserve	1800 x 1200	Welcome to Kalgulup Regional Park Place of fire	Welcome to Kalgulup Regional Park Nejek frame first and most most of most depend park in small of them hands substitute from the first frame of the first frame of them hands substitute from the first frame of the first
Maidens Reserve	1800 x 1200	Maidens Reserve Landforms and links	Winders Reserve Winders Roberts Winders Roberts Winders Roberts Winders Roberts Winders Winder Winders
Maidens Reserve	1600 x 590	Maidens Lookout Walk	Marian Lookout Walk For Island Galaxie Marian Lookout Walk Marian Loo
Maidens Reserve Maidens Lookout Walk	300 x 400	12 x trailside signs	Coost sword sedge Lepidopome gladiatum Maidens Reserve is an important cultural site where frichweiter seepages can be found in where frichweiter seepages can be found in of rubber and degies were used by Noongar people to locate frieth water, and water of curuse has navary important uses. Askief from finding, medicinal compounds or make tonck from plants the discharge that can be setter raw, while the seeds of other accides were ground into a flour and baked into damper. Purple tassles is one of the various species of lillies that produce an abundance of edible and notice their bright yellow flowers. Accide seeds are a very good source of flats, protein and calcibolydrates, and were part of a traditional historyate list that one bester raw, while the seeds of other accides were ground into a flour and baked into damper. Accides are well-known throughout Australia for their bright yellow flowers. Accides seeds are a very good source of flats, protein and calcibolydrates, and respect to a traditional historyate and and list that protein and calcibolydrates, and respect to a traditional historyate list that one bester raw, while the seeds of other accides were ground into a flour and baked into damper. Accides are well-known throughout Australia for their bright yellow flowers. Accides seeds are a very good source of flats, protein and calcibolydrates, and respect a very their bright yellow flowers. Accides seeds are a very good source of flats, and respect to a traditional historyate and respect to a seed to a respect to a traditional historyate and respect to a

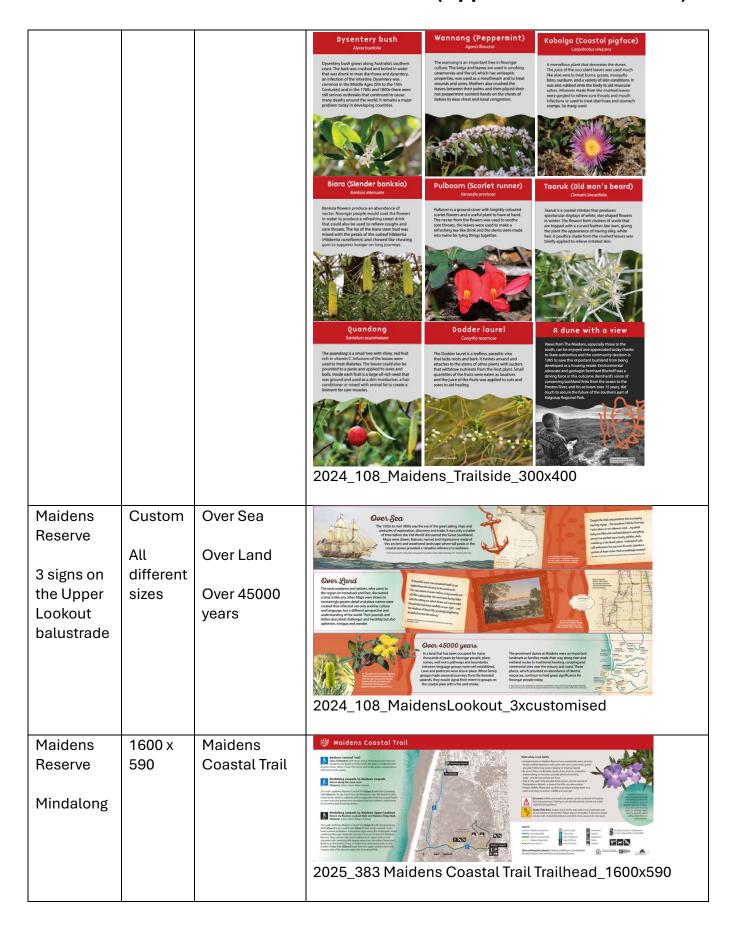

Hay Park	1600 x 590	Hay Park Kalgulup Regional Park	Negreta is studied for such of the facility of
Manea Park	1800 x 1200	Welcome to Kalgulup Regional Park Place of fire	Welcome to Kalgulup Regional Park Higher liquid risk in our deared upper liquid in the case of the second of the common and the case of the common and the case of the case o
Manea Park	1800 x 1200	Manea Park Woodlands and wetlands	Mance Park Hardrain our further, years further and an experience of the control
Manea Park X 2	900 x 1200	The killer beneath your feet	The killer beneath your feet Committee of the committe

Manea Park Pultaneae Loop	180 x 280	17 x trailside signs	Bioro (Slender Banksio) All and the attraction Person on the springle Perso
			The to form. Thick, receipt bows to gray white to be Distinction of Province of the Distinction of the Distinct of the D
			Danja (Woody Pear) Accord adapta Coojing (Orange Wottle) Accord adapta Coojing (Orange Wottle) Accord adapta Coojing (Orange Wottle) Accord adapta Accord ac
			Pondii (Speanwood) Kuntee erichida East shub b 3m eld droping branches and shub had be all the all th
			Woodland Understorey Woodland with a risk of the spoors and others with the state of the spoors and others with the state of the spoors and others with the state of the spoors and others with such orders. 2024_229_Manea Trailside_180x280
Shearwater Tuart Forest	1800 x1200	Welcome to Kalgulup Regional Park Place of fire	Welcome to Kalgulup Regional Park Way to make the many district and it to form bulburg an kalaka large specific of the control of the contro

Shearwater	1800 x	Shearwater	
Tuart Forest	1200	Tuart Forest Wonderful woodlands	The second particular of the control
25 x locations in the regional park	300 x 400	Kalgulup Regional Park	Explore Kalgulup Regional Park online with the ebook. Scan the QR code below or visit go.dbca.wa.gov.au/pvs-krp-ebook 2024_231_Ebook_210x300

Welcome to Kalgulup Regional Park

Mangrove Cove

五 **沐**

Map Legend

Wetland

Regional Park

O Recreation Site

Sheltered Picnic Table No Pets

රේ Cycle Trail

Lookout

4WD Access

Soat Ramp

Information

Toilets

Shower

Playground

Kalgulup Regional Park is one of several regional parks created in Western Australia to protect significant natural, cultural, recreation and community values.

The park is a mosaic of lands around the Greater Bunbury area, Leschenault Estuary and Collie, Brunswick and Preston rivers. It contains wetlands and woodlands, threatened habitats and species, and important cultural sites. The diverse landscapes combined with the wildlife that depend on these natural areas make this park unique.

A park for people

Areas like these play an essential role in the health of an urban community. The tranquility and beauty of natural areas can help reduce stress and improve wellbeing by providing perfect places for recreation and relaxation.

Kalgulup Regional Park has something to offer year-round and is just waiting to be explored, so get out there and discover

the special places that the park protects.


Caring for Kalgulup Regional Park

Kalgulup Regional Park protects a range of values and landscapes that are becoming increasingly rare with expanding urban development. As park users and neighbours, you play an important role in protecting these values and maintaining the health and biodiversity of this park.

Stay on the path: Help prevent erosion, trampling plants and the spread of Phytophthora dieback, a disease that kills our native plants.


Protect wildlife: Please pick up after your dog and keep them on a leash whenever you are not in a designated dog exercise area to protect wildlife and your pet.

Be clean: Don't litter or dump rubbish or garden waste. Dumping of rubbish is illegal.

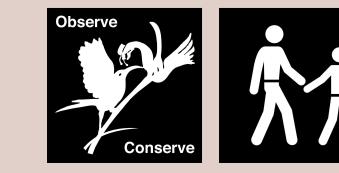







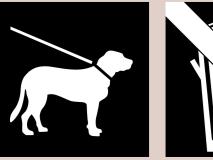





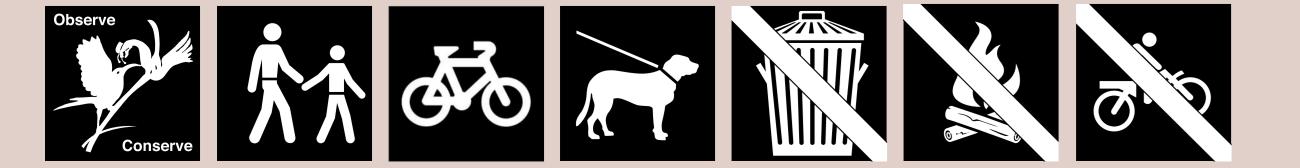

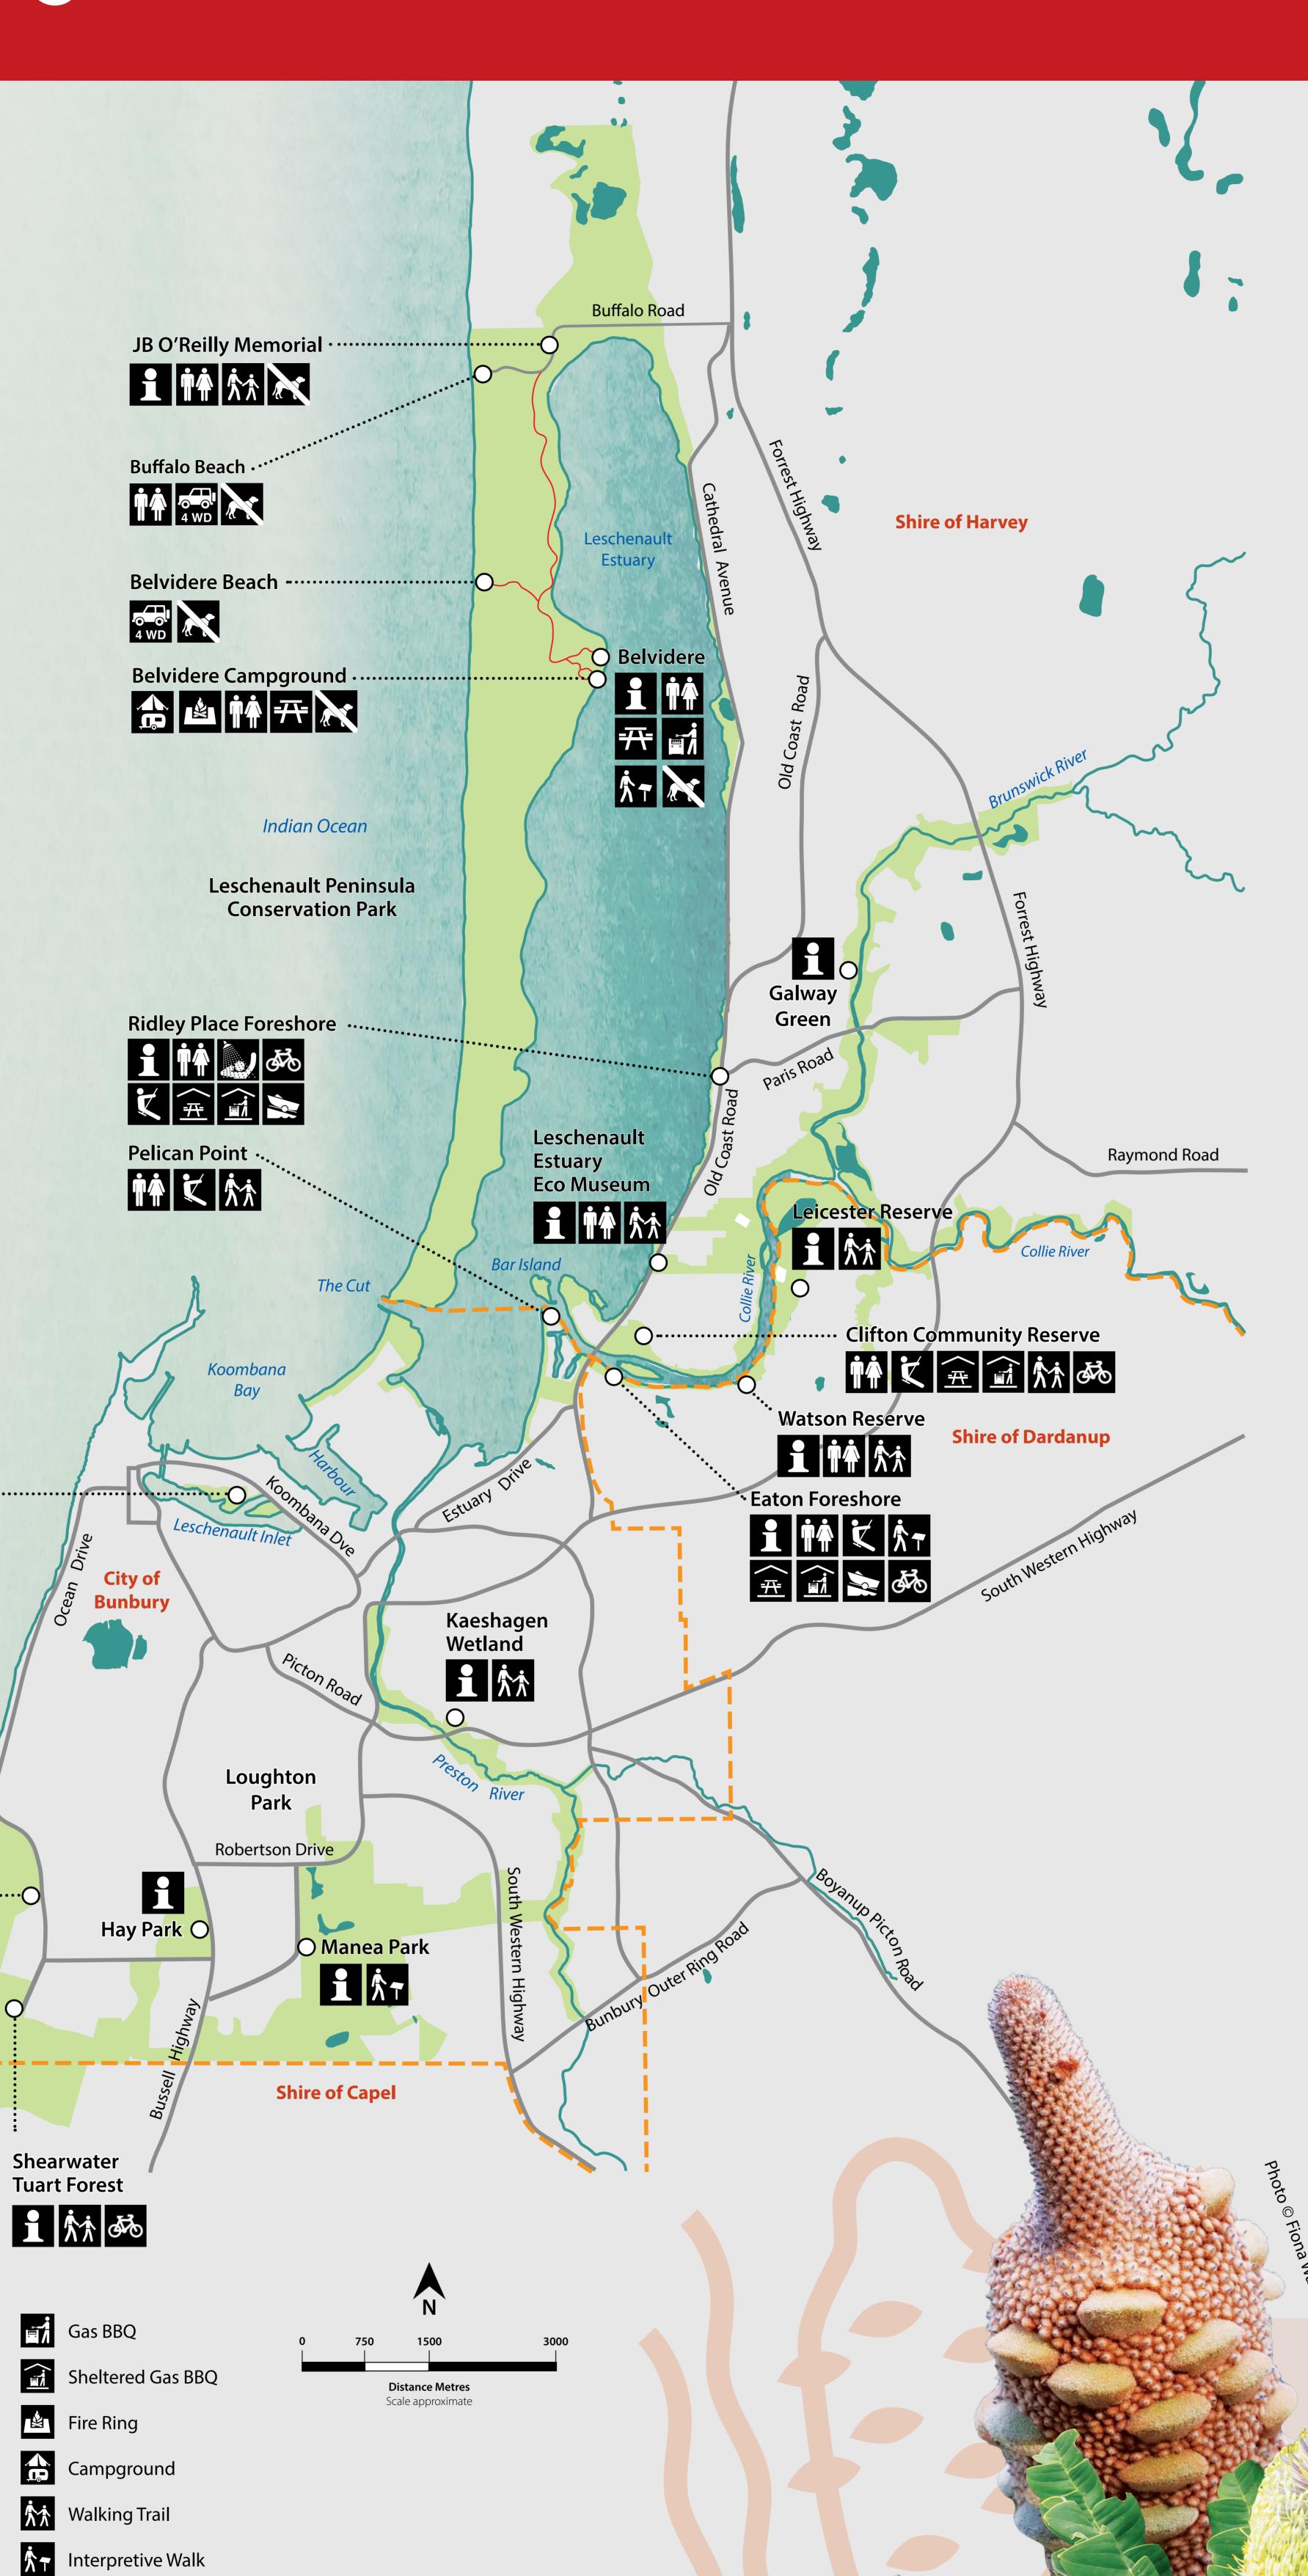

The large flower spikes of

mungite (Banksia grandis) can

Shearwater Tuart Forest during

be seen in Manea Park and

spring and early summer.

Photo © Stuart Williams

Kalgulup (pronounced 'kaal-gool-up') is a Noongar word meaning 'place of fire'. It is a place surrounding Quobba Keip Boya (a place of pretty rocks and water), which sits within the lands of the Pinjarup, Wardandi, Kaneang and Wiilman people.

Place of fire

Karla (fire) and its elements (smoke, coals, ash) is at the koort (heart) of Noongar culture. For thousands of years, fire has supported life by providing warmth, light, cooking, healing and protection. Noongar stories, wisdom and lore were shared around campfires, and fire was used in hunting, ceremony and caring for Country. Fire has also been a major force in shaping Australian landscapes and biodiversity.

> The colour of the park motif represents fire and

> > other red elements that

abound in nature.

Where there's smoke

The motif for Kalgulup Regional Park is the distinctive woody spike and leaves of the mungite or bull banksia (Banksia grandis), a tree which is typically found in the jarrah forest of the Darling Range and in coastal woodlands.

Noongar people made a sweet drink and also sucked the nectar directly from the large flower spikes. When mature, the woody spikes of *mungite* were used by Noongar people as fire sticks. As they travelled through country, a smouldering spike could be carried to light a fire at the next camp.

The wavy lines in the motif represent smoke from the smouldering fire stick and from the campfires that were common around the estuary and rivers when Noongar people camped there. They came to the estuary in large numbers to fish and practice seasonal customary activities in their country as they have for thousands of years and continue to do so today.

We acknowledge the Traditional Owners of these lands and waters, the Pinjarup, Wardandi, Kaneang and Wiilman people of the Bibbulmun Nation, and pay our respect to elders past, present and emerging. Please tread lightly and respectfully on this land and enjoy your visit.

Male and female forest

Photo © Patrick Tomkins

red-tailed black cockatoos

For further information contact the Department of Biodiversity, Conservation and Attractions Corner Dodson Road and South Western Highway, Bunbury.



Department of **Biodiversity**, **Conservation and Attractions**







Phone (08) 9725 4300.

Eaton Foreshore is an open parkland on the edge of the Collie River with a range of visitor facilities so that you can stay awhile and enjoy these peaceful surrounds.

Nature is all around with sedgelands and woodlands fringing the river and a variety of birdlife on and near the water. Ospreys glide overhead in search of fish to catch and dolphins are frequent visitors as they move to and from the estuary along the river.

The estuary, river and other waterways in the area are also very important cultural sites. They hold many thousands of years of meaning for Noongar people who have an ongoing responsibility to care for these lands and waters.

Let's explore!

Sealed paths, a jetty and small, sandy beaches provide easy access to the river where you can dip your toes in the water or find a shaded seat to rest and take in the views.

Ebb and Flow

Eaton Foreshore overlooks the lower reaches of the Collie River where it flows into the Leschenault Estuary. This is a dynamic environment where freshwater and saltwater meet. Through the action of tides that rise and fall, saltwater travels 10km up the Collie River, so here at Eaton Reserve the river is very much influenced by the estuary.

Magnificent mix

The Leschenault Estuary and lower Collie River feature a diverse mix of habitats that combine seagrass meadows, saltmarsh, sedgelands and mangroves with fringing woodlands and freshwater wetlands. This in turn supports a wonderful mix of wildlife and a great diversity of waterbirds.

Some waterbirds live here year-round, some are seasonal visitors and some are migratory waders that travel vast distances each year from their breeding grounds in the northern hemisphere and use the estuary as an important stopover to feed and rest.



P Tr A DI C

Regional Park Boundary Eaton Foreshore Walk Koorliny Beelya Trail

Distance: 3km return. Allow 1 hour.

A dual-use path that winds through woodlands along the edge

of the Collie River to Pratt Reserve Lookout. Trailside signs on

this walk provide insights into Noongar culture and their long

relationship with boodjar (land) and beelya (river). Beyond the

into Watson Reserve. There are also designated dog exercise

lookout are steps that descend to the river and then a boardwalk

areas where pets can be let off the leash for exercise but must be

Koorliny Beelya Trail

under effective control at all times.

You are here

ooooo Steps and boardwalk 🛬 Boat Ramp 🔐 Sheltered BBQ 1 Information

Playground Sheltered picnic table

Dog Exercise Area

Dogs are not permitted to be off leash in a playground or BBQ area and must remain out of bushland areas.

Island sanctuaries

In this urban landscape, the woodlands and wetlands that can still be found along the edge of the Collie River are a vital but vulnerable refuge for wildlife. Isolated islands are important too, because of the protected habitat they provide. Bar Island, at the mouth of the Collie River, and Alexander Island provide places where waterbirds can safely roost, nest and feed.

Exceptional estuaries

Estuaries are clearly important environments. They provide safe harbours for people and sheltered waters for wildlife. They act as fish nurseries and support a diverse mix of plants and animals. They are rich in traditional resources, and in the southwest they were places where Noongar people gathered to camp, hunt, conduct ceremonies and care for country and culture. They are also places of beauty for recreation and quiet reflection, where we can connect with nature.

Alexander Island is a refuge where birds can nest and roost in the paperbark and sheoak trees, or nest and feed undisturbed in the rushes below.

Walk and ride safely

Be smart: Wear comfortable, sturdy shoes and sun protection. Avoid walking on hot days and take plenty of drinking water.

Sealed paths are shared paths. Pedestrians please keep left to let cyclists and scooters pass safely. Riders please warn pedestrians as you approach and pass at a safe speed.

Protect wildlife: Please pick up after your dog and keep them on a leash when not in designated dog exercise areas to protect wildlife and your pet. Dispose of rubbish in the bins provided.



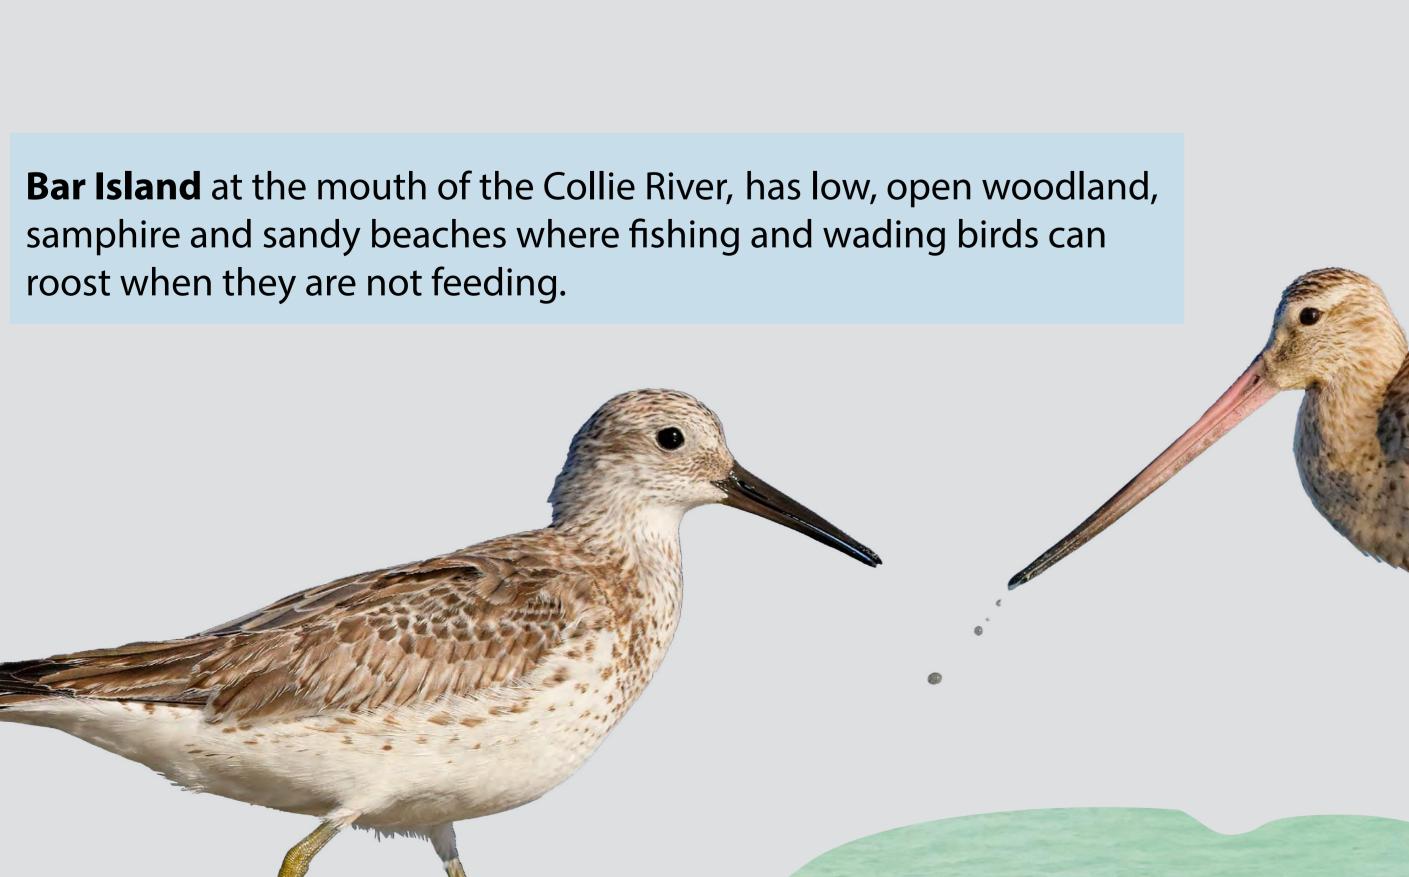


Photo © Georgina Steytler



Great knot

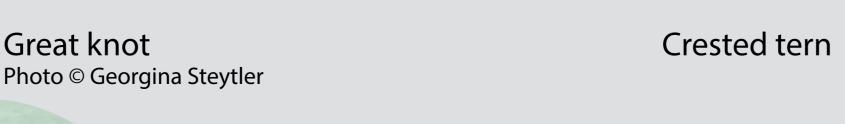

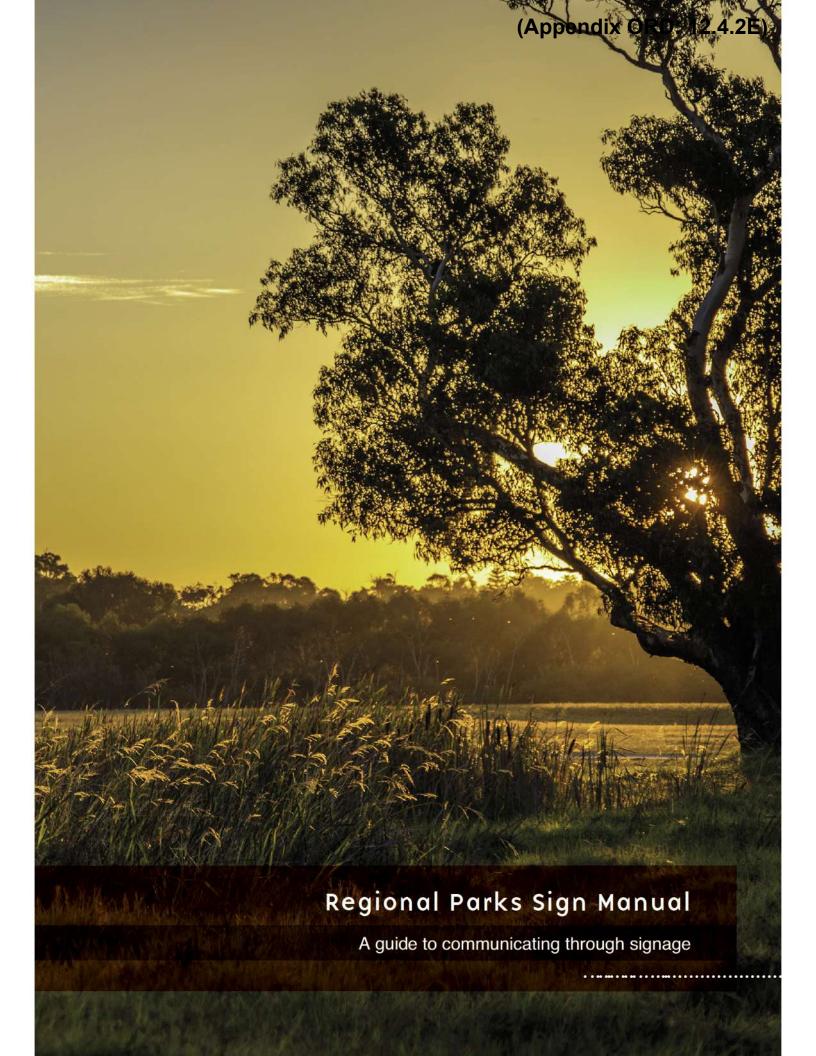

Foreword



The Department of Biodiversity, Conservation and Attractions manages a variety of tenure across Western Australia, including a system of regional parks that lie within urban areas.



Within the Perth metropolitan area there are eleven regional parks that cover a total of about 50,000 hectares.



Perth's regional parks include river foreshores, ocean beaches, wetlands, banksia woodlands and the Darling Scarp. They are used every day by local residents and visitors, from early morning walkers to students on school excursions, and tourists on guided tours.



Many other forms of recreation are available in these parks, often in areas of high conservation value. Thomsons Lake in Beeliar Regional Park, for example, provides an opportunity for birdwatching because it is a stopping point for migratory birds from Japan, Russia and China, which are protected by international agreements.



Managing the high number of visitors and providing information about the different natural features and facilities in each park presents a challenge to the Department of Biodiversity, Conservation and Attractions, local councils and community groups, who are advocates for the parks and the values they protect.



Park signage is an obvious way to help meet this challenge. Signs are a highly visible and effective tool in recreation management if used efficiently and skillfully.



This sign system, designed for regional parks, recognises the individual nature of each park and at the same time, links them together as part of the city's most extensive open space system. This system is based on a hierarchy of signs that have been developed to identify, inform, direct, regulate and warn.



This manual sets out detailed specifications to plan, build and install signs and information shelters in regional parks and to maximise their value to visitors and park managers. These specifications have been developed to optimize design effectiveness, such as legibility, user recognition and to help strengthen the community's awareness and appreciation of regional parks.

A great deal of time and effort has been put into these specifications, and the department is indebted to all those who have contributed to this document.

Contents

INTRODUCTION	
Regional Parks Sign System	5
Locations of Perth's Regional Parks	6
How to use this Manual	7
Sign System Types	9
BRANDING	
The three elements	10
Park colours and motifs	11
Typeface	13
SIGN CATEGORY	
Introduction	14
Wayfinding Signs	15
Management Signs	23
Visitor Risk Signs	25
Interpretation Signs	27
SIGN LIST	
Introduction	30
Wayfinding Signs and Frames	31
Management Signs and Frames	32
Risk Signs and Frames	32
Interpretation Signs and Frames	33
SIGN ORDERS AND INSTALLATIONS	Section 1
Process	34
Wayfinding Signs RP-MRWA	36
Ordering Management Signs Ordering Risk Signs	38
Ordering Interpretive Signs	40
Installing sign plates	42
Installing vinyl wraps	43
SIGN FRAMES	
Glossary of Terms and Measurements	44
RPF Series	45
Preliminary Clauses	50
Material Specification	52
Footing	53
Maintainence	54
VINYL WRAPS	
Ordering	56
Preparation	57
Application	58
Purchasing Policy	59
Key Resources	60
Other Communications	61
Confidentiality & Ownership	62
Appendix A	63
Appendix B	64

Introduction

Regional Parks Sign System

There are currently 11 regional parks, covering over 50,000 hectares of land, within the Perth metropolitan areas. These parks have been reserved for their particular conservation, recreation, heritage and landscape values. They represent a wide range of different environments and scenery types and support a broad spectrum of recreation opportunities for visitors.

In some cases, the parks are fragmented and made up of discrete areas of land that are separated by transport corridors and other land uses. Uniting the separate parts of each park, and uniting the parks that comprise the park network, is a major challenge.

The Regional Parks Sign System has been designed to address this challenge. Through consistent use of distinctive materials and graphics, the sign system and branding aims to establish a recognisable and memorable identity for the parks, individually and as a group.


The Sign System has been developed in response to both the natural and social values of the regional parks and to effectively convey information to the public across the diverse cultural contexts and landscapes in which the signs are to be located. It has also been designed to incorporate and reinforce the department's corporate identity.

The distinctive branding has been designed to be graphically simple, adaptable to different applications, stylistically consistent and individually evocative of the special values and character of the parks that it represents.

Both the branding and the sign system form the standard for signage in the regional parks. It is important that new signs are selected, ordered, manufactured and installed according to this sign system to establish and maintain a consistent identity and quality of information across the regional parks.

For more information about the Regional Parks Sign System and branding, contact the Design Studio Coordinator Ph: (08) 9219 8578 Email: signdesign@dbca.wa.gov.au

For more information on regional parks, contact the Regional Parks Unit Manager Ph: (08) 9442 0300 Email: regional.parks@dbca.wa.gov.au

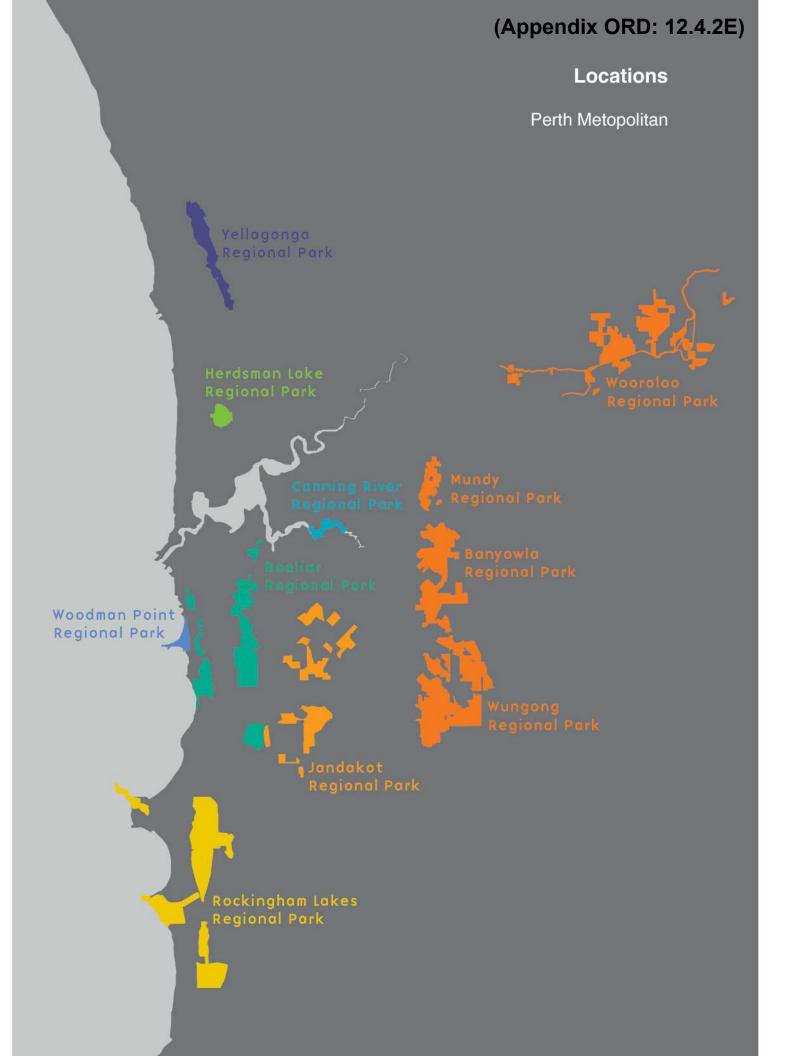

Introduction

How to use this Manual

This manual is the guide for all regional parks staff and Local Government authorities to select, manufacture, install and maintain signs within the regional parks network.

Sign design and development is a process

The manual takes the user step by step through that process, which is outlined on the next page. It is important that each step is considered so that regional parks signs meet design, construction and installation standards.

Why are standards important?


Standards ...

- assist you in planning
- assist you in communicating with the visitor on site
- ensure there is consistency across tenure and regions
- help keep production costs down
- maintain a consistent, uniform presentation and positive image across the agency
- ensure legibility (font type, font size, colours)
- ensures warranties are not voided
- optimises the visitor experience while creating safer visitor environments.

Standards apply to the design, construction and installation of sign frames, vinyl wraps and sign plates. Standards also apply to park colours, motifs and typeface. These terms are explained in the following drawings.

Introduction

How to use this Manual

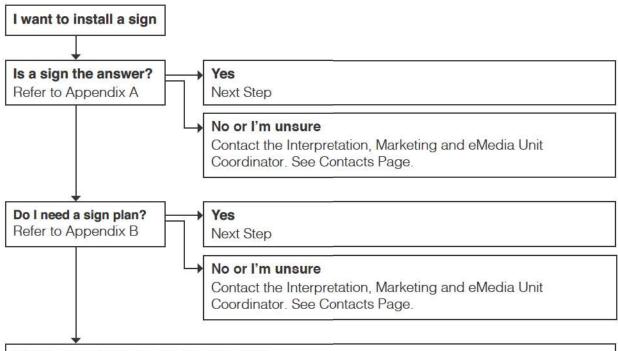

Which sign would best suit my needs?

- Refer to Branding
- Refer to Sign Category, which also includes illustrations of the sign types
- Refer to the Sign List to pick the correct sign type.

How and where do I get the sign frames and sign plates produced?


- Identify sign type: Refer to Sign Category, which also includes illustrations of the sign types. Refer to the Sign List.
- Put together sign copy (text) based on type of sign category. Identify other elements of sign layouts: Symbols (using Symbols Guides in Key Resources) and sourcing illustrations and/or photographs to support sign copy using the Interpretation Unit Project Checklist. Other useful tools like the Hazard Manual, Regional Parks Communication Strategy an Interp Plans for Regional Parks are provided for your information.
- Use the correct order form and submit to the Design Studio Coordinator.

How are sign frames manufactured and installed? Refer to Sign Orders and Installation How are sign plates or vinyl wraps attached to sign structures? Refer to Maintainence How are sign frames and vinyl wraps maintained? Refer to Maintainence

Introduction

Sign System Types




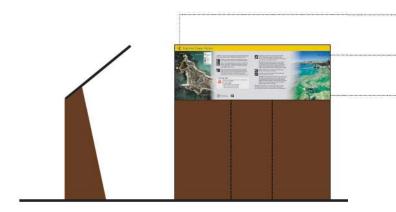

Sign plate is branded with park specific colour, motif and typeface.

Full colour printed vinyl on aluminium sign plate*

Sign plate is affixed to **mild steel frame** using spacers

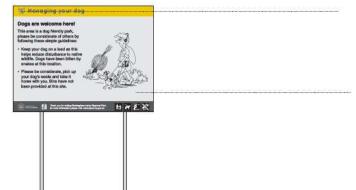

Sign plate is branded with park specific colour, motif and typeface.

Full colour printed vinyl on aluminium sign plate* affixed on reverse with unistruts and brackets and mounted on to galvanised poles with caps.

Note: *Vinyl wraps will be digital prints finished with UV overlaminate. Sign plates are digitally printed, full colour cast vinyls with a two part anti-graffiti spray for all permanent signage. Temporary signage may use a UV overlaminate in lieu of the anti-graffiti spray. The finishing processes mentioned above are highly recommended in order to prolong the longevity of the sign in situ when subject to harsh environmental factors over time.

Branding

The three elements

The three elements of branding

All regional parks within the State now have dedicated branding that allows the parks to be recognised as a group and yet stand apart individually from each other. The branding elements, unique to each park, consist of two colours and a motif. These, together with the typeface, make up the visual identity of the regional parks network.

Park Colours

Each park has two colours assigned to it for branding purposes: a background colour and an associated motif + typeface colour.

The background colour is a defined PMS colour, unique to each park or a group of parks (i.e Darling Range) and based on the Pantone Matching System (except Rockingham Lakes Regional Park whose colour has been defined by CMYK values).

The colour of the associated typeface is either charcoal or white. If charcoal is specified, it is to be produced as 80% black. The typeface colour is also applied to the motif and any other graphical elements including text and monochrome logos that are included on the signage.

The values prescribed for the specified colours must be strictly adhered to and not compromised in any way.

Note on colour matching: Do not use the pages that follow for colour matching purposes. Refer to the PMS or CMYK specifications for each park.

Park Motifs

The motif is a simple monochrome graphic used to create a visual identifier for each park. It must sit on the background colour assigned to the respective park.

The motif must not be distorted, stretched, skewed or warped and must be proportionally scaled at all times. It must be used as a whole image and never in part only. The minimum size for the motif in any digital print product is 10mm x 10mm.

Note: If required, the motifs can be obtained in the appropriate digital format from the Design Studio with permission from the Regional Parks Unit in the department.

Typeface

The principle typeface is Base Nine and the supporting typeface is Helvetica.

Branding

Park colours and motifs

Background Colour PMS 166C

Motif+Typeface Colour White

Note:

Regional Parks of the Darling Range were separated into four separate Regional Parks: Wooroloo Regional Park, Mundy Regional Park, Banyowla Regional Park & Wungong Regional Park.

They however retain their original motif and colours.



Wooroloo Regional Park

Mundy Regional Park

Banyowla Regional Park

Wungong Regional Park

In this example, elements of branding are identified for Wooroloo Regional Park. The following page defines the elements of branding for all other regional parks.

Background Colour

PMS 166C



Wooroloo Regional Park

Motif Colour

White

Regional Parks Typeface

Base Nine Regular

Typeface colour

White

Branding

Park colours and motifs

Background Colour PMS 144C

Motif+Typeface Colour 80% Black



Jandakot Regional Park

Background Colour CMYK 0/12/100/7

Motif+Typeface Colour 80% Black



Rockingham Lakes Regional Park

Background Colour PMS 376C

Motif+Typeface Colour 80% Black



Herdsman Lake Regional Park

Background Colour PMS 339C

Motif+Typeface Colour White



Beeliar Regional Park

Background Colour PMS 632C

Motif+Typeface Colour White



Canning River Regional Park

Background Colour PMS 2718C

Motif+Typeface Colour White



Woodman Point Regional Park

Background Colour PMS 668C

Motif+Typeface Colour White



Yellagonga Regional Park

Branding

Typeface

The Typeface

The principle typeface for regional parks is Base Nine and the supporting typeface is Helvetica.

PRINCIPAL TYPEFACE

Base Nine Regular is to be used for branding park names, site names, headings and titles. The only exception is on risk signage where Helvetica Bold replaces Base Nine even for a heading.

BASE NINE Regular

A	B	C	D	E	F	G
Н	I	J	K	L	M	N
0	P	Q	R	S	T	
U	V	W	X	Y	7	

SUPPORTING TYPEFACES Helvetica is always used in all other instances as described below.

HELVETICA Bold

A	В	C	D	E	F (L
H	١,	JK	L	N	IN	
0	P	Q	R	S	T	
U	V	W	X	Y	Z	

123	4 5	67
8 9 10	1	1 12
13 14	1.,	;:!
()?		

Helvetica Bold is used for sub headings for management and interpretive signage, supporting Base Nine as a choice for headings.

HELVETICA Regular

ABCDEFG HIJKLMN OPQRST UVWXYZ

abcdefg hijklmn opgrstu VWXVZ

12345678 9 10 11 12 13 14.,;:!()?

Helvetica Regular is used as the supporting typeface.

Helvetica Oblique may only be used in specific instances - for example, the scientific names of species.

Sign Category

Introduction

The Regional Parks Sign System consists of four categories of signs, with different types and sizes of signs and supporting structures in each category. The four categories are:

- A) Wayfinding
- B) Management
- C) Visitor Risk
- D) Interpretation

Wayfinding Signs

Visitor Orientation signs include directional, orientation, site identification and boundary signs. Most signs in this category use a minimum of words and basic directional symbols. They aim to help visitors identify the regional park, access it and locate facilities or features.

Management Signs

Management signs include visitor regulatory (symbol signs), orientation and information signs. They may be permanent or temporary. They generally combine brief written messages with standard management symbols. A slash through a symbol indicates activities that are not allowed or not catered for.

Management issues addressed by this category of sign include environmental protection and rehabilitation, access restrictions, recreational activities and temporary parking areas.

Visitor Risk Signs

Visitor risk signs are a significant part of the department's Visitor Risk Management (VRM) strategy and are used to convey visitor risk messages. Hence, they must adhere to strict guidelines outlined in the department's Hazard Sign Manual. All risk signage must go through the department's Design Studio, as well as an approval process by the department's VRM Coordinator, prior to production to ensure the messages are consistent with departmental requirements and meet our duty-of-care obligations.

Interpretation Signs

Regional Park interpretation signs use a combination of words, images and graphics to convey messages of greater complexity than visitor orientation and management signs. The Regional Parks Sign System includes several types of interpretive signs and structures to suit a variety of situations and purposes.

The following pages provide a more detailed description and visual examples of the sign types within each of the four categories. Whether you are installing just a few signs within a site, or many as outlined in a sign plan, use this manual to select the appropriate signs for the project area. Read the sign details on the Sign List carefully to make sure you select the correct signs in terms of function and size.

Wayfinding Signs

The wayfinding sign category includes directional, orientation, site identification and boundary signs.

MAIN ROADS SIGN RP-MRWA 1

These are directional signs on main access roads indicating where to turn off to reach feature areas and recreation sites. They require Main Roads Western Australia approval, design and manufacture. They feature the park motif.

LOCAL COUNCIL SIGNS RP-MRWA 2

This sign type attaches to existing poles carrying street names and indicates a site name, regional park motif and direction. They require approval for installation from the appropriate Local Government Authority.

PRE ENTRY PREPARATION SIGN

ENTRY This sign type is intended to be placed a minimum of 200m prior to a road turnoff to a feature area, to allow the driver adequate warning and time to reduce speed and turn.

DIRECTORY BOARD

This sign type informs visitors, usually on their arrival at a recreation site, of the location of facilities and features such as walk trails, toilets, etc.

Usually situated in a car park, it is for pedestrians.

DIRECTIONAL SIGN RP-W 5

This sign type indicates to pedestrians and path users the direction and distance of facilities and recreational opportunities such as walks. It may feature a single direction or multiple directions, and be single-sided or double-sided.

PRIMARY ENTRY SIGN

RP-W 6A

This sign type depicts the regional park name, site name and park motif. It is used on main roads or at the entrance to major feature areas. It is designed to be read from a vehicle. The sign may be single-sided or double-sided.

PRIMARY SITE ID SIGN RP-W 6B

This sign type is primarily used to identify a site within a regional park and also depicts the regional park name. It functions similarly to a primary entry sign and is used at the entrance to major sites to create a sense of arrival. Therefore, it is similar in size to RP-W 6A, may be single-sided or double-sided and clearly identifies the site name.

SECONDARY ENTRY SIGN

RP-W 7A

This sign type depicts the same information as HP-W 6A, however it is smaller in size and designed for pedestrians. It will be used more frequently than RP-O 6A across the regional parks, at the entrances to feature areas. It may be single-sided or double-sided.

SECONDARY SITE ID SIGN

RP-W 7B

This sign type is used to identify a site within a regional park. It functions similarly to a secondary entry sign and is used at the entrance to minor sites to create a sense of arrival. Therefore, it is similar in size to RP-W 7A, for pedestrians and may be single-sided or double-sided and clearly identifies the site name.

Sign Category

Wayfinding Signs

TRAIL MARKER TOTEMS RP-W 8A,

RP-W 8B and RP-W 8C Different types of totem/posts are used to mark walks or to indicate the direction of facilities such as parking, beach access etc. RP-W 8A allows arrows to be installed to direct pedestrians. RP-W 8B and RP-W 8C sign types additionally allow for 150 x 150mm symbols (describing facilities and visitor activities on site) as well as trail markers and park motifs to be installed.

BOUNDARY SIGNS RP-W 9A, RP-W 9B, RP-W 9C, RP-W 9D, RP-W 9E and RP-W 9F Boundary signs demarcate the boundaries of regional parks. The larger structures, for vehicles, are located at the boundary edges (RP-W 9A) and boundary corners (RP-W 9B).

Smaller structures, for pedestrians are designed for path boundaries (RP-W 9C or RP-W 9D) with provisions for four 150 x 150mm symbols. There is also a fence-mounted option (RP-W 9E).

RP-W 9F is a dual-purpose boundary sign for pedestrians and is to be positioned at pedestrian entry paths into a regional park. It directs visitors towards sites, facilities or walking trails.

Wayfinding Signs RP-MRWA

RP - MRWA 1

MAIN ROADS SIGN

Approval required by MAIN ROADS

RP Brand: 500mm x 500mm or

300mm x 300mm.

Follow Main Roads guidelines for this sign.


RP - MRWA 2

LOCAL COUNCIL SIGN

Approval required by LOCAL COUNCIL

RP Brand: 85mm x 85mm.


Follow Main Roads guidelines for this sign.

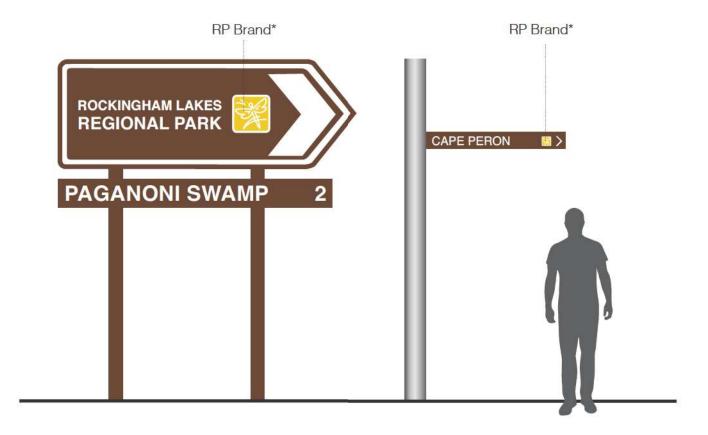

Note: The Branding on Main Roads signs will be digitally printed onto White Class 2 reflective cast vinyl as the sign needs to be reflective. *Print ready pdf files for each of the above sizes are available from the Design Studio upon request.

Follow Main Roads guidelines for this sign.

Wayfinding Signs

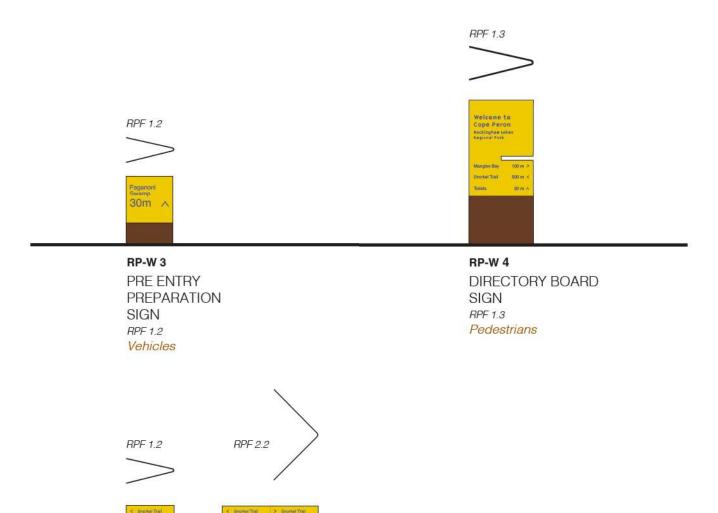

RP-W 5


DIRECTIONAL SIGN

RPF 1.2 or RPF 2.2* dependent on sign orientation and position

Pedestrians


Sign frames must be oriented in a manner such that the bullnose or bend in steel is facing the road/path.

Wayfinding Signs

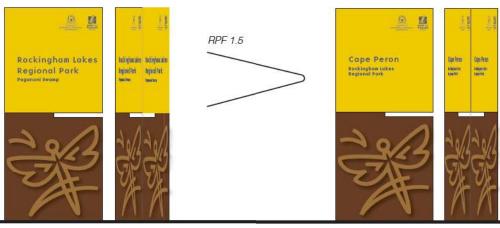

RP-W 6A
PRIMARY
ENTRY SIGN
Single-sided / Double-sided

Single-sided / Double-sided RPF 1.5 Vehicles RP-W 6B
PRIMARY
SITE ID SIGN
Single-sided / Double-sided
RPF 1.5
Vehicles

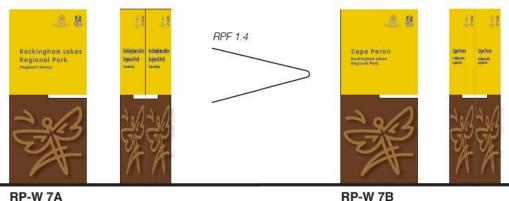


RP-W 7A SECONDARY ENTRY SIGN Single-sided / Double-sided RPF 1.4


Pedestrians


SECONDARY SITE ID SIGN Single-sided / Double-sided RPF 1.4 Pedestrians

Sign frames must be oriented in a manner such that the bullnose or bend in steel is facing the road/path.

Wayfinding Signs

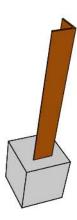

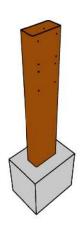

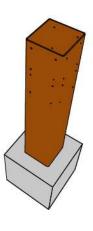

Totem posts in mild steel with directional arrows and / or a maximum of 4 x 150mm x 150mm symbols in aluminium.




RP-W 8A

TRAIL MARKER TOTEM POST

Aluminium profile cut directional arrows on RPF 5.3 sign frame

Pedestrians

Sign frame RPF 5.3 must be oriented in a manner such that the bullnose or bend in steel is facing the pedestrian path.

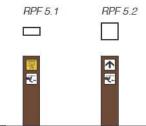


RP-W 8B and RP-W 8C

TOTEM POSTS (Two-way / Three-way)

A max of 4 x 150mm x 150mm symbols on posts RPF Series 5 (RPF 5.2 and RPF 5.3)

Pedestrians

Wayfinding Signs

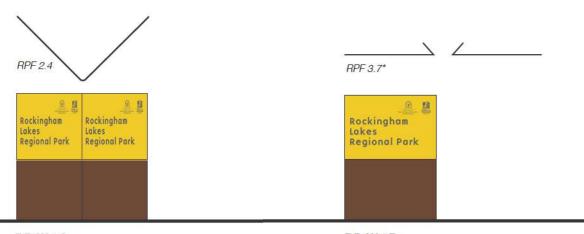


RP-W 9A BOUNDARY SIGN

Boundary corner Double-sided RPF 2.4

Vehicles

RP-W 9B BOUNDARY SIGN

Boundary edge RPF 3.7 Vehicles

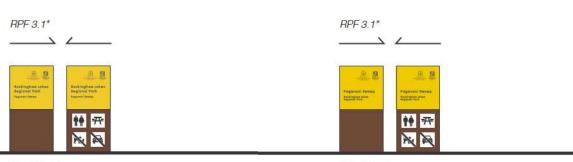

RP-W 9C

Pedestrians

BOUNDARY PATH SIGN
Pedestrian path - entry point eventually
leads to a site within a regional park
(optional - 4 x 150mm x 150mm symbols)

RPF 3.1

RP-W 9D

SITE ID + BOUNDARY SIGN Pedestrian path - direct entry point into a site within a regional park (optional - 4 x 150mm x 150mm symbols)

RPF 3.1 Pedestrians


Sign frames must be oriented in a manner such that the bullnose or bend in steel is facing the road/path. Orientation of sign frames for RPF Series 3 must be determined at sign planning stage. This consequently determines sign design layout and vinyl wrapping procedure.

Sign Category

Wayfinding Signs



RP-W 9E BOUNDARY FENCE SIGN Pedestrians

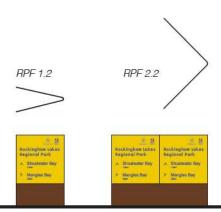

RP-W 9F

BOUNDARY + DIRECTIONAL SIGN
Pedestrian path - entry points into regional parks
Single-sided / Double-sided
RPF 1.2 or RPF 2.2* dependent on sign orientation and position
Pedestrians

Sign frames must be oriented in a manner such that the bullnose or bend in steel is facing the road/path.

Sign Category

Management Signs

The Management Sign category includes management sign plates mounted onto either Regional Parks frames or galvanised poles, and symbols (only) mounted onto Regional Parks frames.

MANAGEMENT SIGNS M3, M4 and M5 on galvanisized poles/ sign frame RPF Series 4.

Permanent signs

Management signs may be manufactured with unistruts on the reverse side, and mounted with brackets onto galvanised poles with caps (RP-M), or mounted without unistruts onto Regional Parks frames (Series 4). Management issues addressed by this category of sign include environmental protection and rehabilitation, access restrictions, recreational opportunities, and construction/site development areas. The sign sizes are M3: 400mm x 300mm, M4: 600m x 450mm and M5: 800m x 600mm.

TEMPORARY + SYMBOL SIGN STRUCTURE

RP-M

Temporary + Symbol signs

Symbols are used to indicate which facilities and activities are available at a site. A black slash through a symbol identifies activities that are not catered for or not allowed. Refer to the 2018 Regional Parks Symbols Index for the list of standard symbols available.

Structures that are designed to display up to four symbols can also cater for temporary signs (either A4 or A3 in size) that can be attached to the top of the structure using pre-drilled holes and cable ties.


Temporary signs are designed for short term use, for example, to identify temporary parking areas during a special event. Temporary signs are to be placed on-site during the day and removed off-site overnight. Discuss your requirements with the Design Studio for special situations.

Sign Category

Management Signs



Aluminium sign plates with unistruts and brackets on reverse mounted on to galvanised poles with caps.

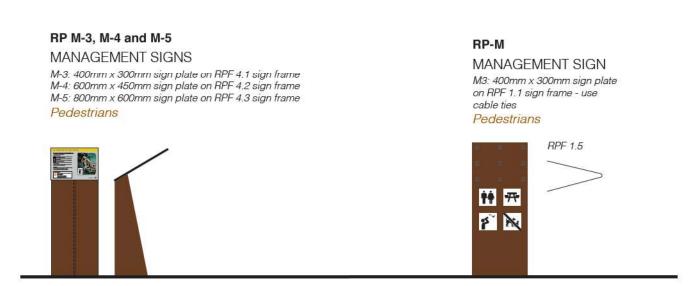

Sign frame RPF 1.5 must be oriented in a manner such that the bullnose or bend in steel is facing the pedestrian path.

Note: The signs illustrated above are examples ONLY, designed for Rockingham Lakes Regional Park. Refer to **Branding** for your regional park's branding elements. For actual specifications and detailed drawings, including measurements and footing dimensions, refer to **Sign Frames**.

Sign Category

Visitor Risk Signs

Risk signs are used to convey visitor risk messages and are a significant part of the department's Visitor Risk Management strategy. Hence, they must adhere to guidelines outlined in the Hazard Risk Manual (see Key Resources).

All risk signage must go through an approval process by the department's VRM Coordinator prior to production.

Sign Content

All visitor risk copy is site and risk-specific, but shares these elements:

- International danger symbol
- What the danger is in words and symbols
- How to avoid the danger



Symbols

The international danger symbol, is a red triangle with red exclamation mark inside the triangle. Under the triangle is the word DANGER also in red. Both the symbol and word are to be red cast vinyl cut.

Other symbols used in the signage will be black on yellow in compliance with Departmental Policy Statement No. 53 – Visitor Risk Management and AS/NZS Standards for warning signs. The department's Risk Symbols Index is to be used as a guide to determine the correct symbols.

Text

Wording is to be kept to a minimum and must contain these three elements:

- Identify the danger in words and symbols
- ii. Describe the danger in words
- iii. Explain how to avoid the danger in words

Example:

ROCK FALL RISK AREA

Rocks may fall without warning from the cliff face before you.

For your safety:

- Stay well clear of cliff face
- Do not go beyond this sign
- Do not attempt to climb

Installing risk signs

All risk signage is to be mounted with unistruts and brackets onto galvanised poles in accordance with the guidelines set in the department's Hazard Risk Manual. If a new sign is to be mounted onto an existing structure (RP-R), approval must be obtained from the department's VRM Coordinator prior to production.

Sign Category

Visitor Risk Signs

RP-R

RISK SIGN

R1: 400mm x 300mm

Pedestrians
Sign to be affixed onto existing structure.

Approval from Parks and Wildlife VRM CoOrdinator.



RP-R1 RISK SIGN R1: 400mm x 300mm Pedestrians

RP-R3 RISK SIGN R3: 600mm x 450mm Pedestrians









Aluminium sign plates with unistruts and brackets on reverse mounted on to galvanised poles with caps.

Note: The signs illustrated above are examples ONLY, designed for Rockingham Lakes Regional Park. Refer to **Branding** for your regional park's branding elements. For actual specifications and detailed drawings, including measurements and footing dimensions, refer to **Sign Frames**.

Sign Category

Interpretation Signs

Interpretation signs use a combination of words, images and illustrations to convey messages of greater complexity, to enhance visitors' understanding, appreciation and enjoyment of the park and its values.

The Regional Parks Sign System includes different types of interpretive signs and their respective structures. The sign types and functions, and supporting sign structures are listed below.

Sign sizes

RP IP-1: 400mm x 300mm

RP IP-2: 600mm x 450mm

RP IP-3: 800mm x 600mm

RP IP-4: 900mm x 1200mm

(replaces older signs that were previously 800mm x 1200mm**)

RP IP-5: 1600mm x 600mm (equivalent of 2 x IP-3 panels)

Trailhead signs are placed at the start of a walk or trail, and trailside signs are placed at intervals along the walk, usually next to or within sight of the topic on the sign. These signs are typically installed on an incline for comfortable viewing.

Interpretive signs not on trails and used near the entry to a site, at a recreation hub or to interpret specific site values include sign IP-3, IP-4 and IP-5.

Sign frame options

The following inclined signs can be mounted on the appropriate Regional Parks Frame (RPF Series 4) or department's sign system frames (PG Series):

IP-1 sign on an RPF4.1 sign frame or a PG31 frame*

IP-2 sign on an RPF4.2 sign frame or a PG32 frame*

IP-3 sign on an RPF4.3 sign frame or a PG33 frame*

IP-5 sign on an RPF4.5 sign frame or a PG36 frame*


The larger 900mm x 1200mm interpretation signs may be installed in a sign shelter or plaza-style frame PG35 frame, which can accommodate one or two (back-to-back) IP-4 signs.

Note:*Sign Frames PG31, PG32, PG33 and PG35 and PG36 form a part of the department's sign system. For detailed drawings for the fabrication of these frames, refer to the Key Resource Folder/Page or contact the Design Studio Coordinator.


**Original 800mm x 1200mm signs can be replaced by current 900mm x 1200mm sign plates even in pre-existing shelters. The space must be clad first before the install of new signs. For more information on how to arrange this, please contact the Design Studio Coordinator.

Sign Category

Interpretation Signs

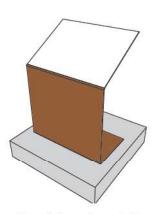



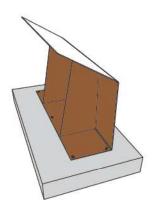

Aluminium sign plates mounted on to mild steel sign frames RPF Series 4, separated by spacers.

TRAILHEAD / TRAILSIDE / INTERPRETIVE SIGNS

IP-1: 400mm x 300mm, IP-2: 600mm x 450mm, IP-3: 800mm x 600mm sign plates on RPF 4.1, 4.2 AND 4.3 sign frames respectively.

Pedestrians

TRAILHEAD / INTERPRETIVE SIGN

IP-5: 1600mm x 600mm sign plate on RPF4.5 sign frame.

Pedestrians







Note: The signs illustrated above are examples ONLY, designed for Rockingham Lakes Regional Park. Refer to **Branding** for your regional park's branding elements. For actual specifications and detailed drawings, including measurements and footing dimensions, refer to **Sign Frames.**

Sign Category

Interpretation Signs

RP IP-1 TRAILSIDE / INTERPRETIVE SIGN

IP-1: 400mm x 300mm sign plate on PG31 sign frame. Pedestrians

RP IP-2

TRAILSIDE / INTERPRETIVE SIGN

IP-2: 600mm x 450mm sign plate on PG32 sign frame. Pedestrians

RP IP-3

TRAILSIDE / TRAILHEAD /INTERPRETIVE SIGN

IP-3: 800mm x 600mm sign plate on PG33 sign frame. Pedestrians








RP IP-4

PLAZA STYLE INTERPRETIVE SIGN

IP-4: 900mm x 1200mm sign plate on PG35 sign frame.

Pedestrians

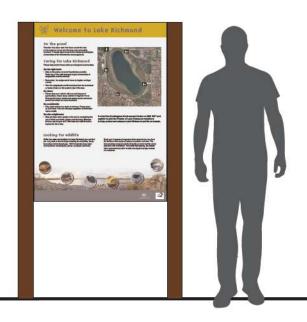

Note: The signs illustrated above are examples ONLY, designed for Rockingham Lakes Regional Park. Refer to **Branding** for your regional park's branding elements. For actual specifications and detailed drawings, including measurements and footing dimensions, refer to **Sign Frames.**

Sign List

Introduction

The Regional Parks Sign list is a detailed inventory of all sign types in the Regional Parks Sign System and includes each sign's frame and sign plate specifications.

Use this list to identify the category of sign required. Then select the best sign type in that category to suit the task. The title and sign content columns will assist selection if more than one sign type seems suitable. For additional guidance on sign type selection, refer to the pages that follow.

Custom signs

While it is important to maintain sign standards across Regional Parks, signs may occasionally need to be customised for unique or problematic sites or situations.

In this event, the Design Studio can assist Regional Parks Unit staff and others in designing a sign in accordance with the principles and standards of the sign system. The custom sign must be approved by the Design Studio Coordinator and Regional Parks Unit.

Wayfinding Signs and Sign Frames

Regional Parks Sign List

NO	AUTHORITY / APPROVAL	SIGN TYPE	AUDIENCE	SIGN CONTENT (COPY)	DIRECTIONAL ARROW	SIGN FRAME MATERIAL	SIGN FRAME TYPE	D/S OR S/S	SIGN FRAME + MORE INFO	COLOUR	LOGOS / CORPORATE IDENTITIES
RP - MRWA 1	MRWA	MAIN ROADS SIGN	Vehicles	Regional Park Name (Park Specific) Distance (to be inserted)	Site Specific	ALUMINIUM	Applied Vinyl	S/S	300x300 (mm)/ 500x500 (mm) symbol on sign	RP branding	RP brand motif
RP - MRWA 2	MRWA + LGA	LOCAL COUNCIL (LGA) SIGN	Vehicles	Regional Park Name (Park Specific) / Site Name (Site Specific)	Site Specific	ALUMINIUM	Bracket	D/S	85x85 (mm) symbol	RP branding	RP brand motif
RP-W3	DBCA+LGA	PRE ENTRY PREPARATION SIGN	Vehicles	Regional Park Name (Park Specific) / Site Name (Site Specific) Distance 200m or 300m	Site Specific	MILD STEEL	Freestanding / Mounted	s/s	RPF 1.2	RP branding	N/A
RP-W 4	DBCA	DIRECTORY BOARD SIGN	Pedestrian	Welcome to Site Name (Site Specific) Regional Park Name (Park Specific) List of Trail/Facilities, Distance + Directional Arrows	Site Specific	MILD STEEL	Freestanding	s/s	RPF 1.3	RP branding	N/A
RP-W 5	DBCA	DIRECTIONAL SIGN	Pedestrians	(Site specific copy to be supplied) based on sign position, orientation and sign plan. Note: Maximum of 5 lines	Site Specific	MILD STEEL	Freestanding	D/S on S/S	RPF 1.2/ RPF 2.2	RP branding	N/A
RP-W 6A	DBCA	PRIMARY ENTRY SIGN	Vehicles	Regional Park Name (Park Specific) Site Name (Site Specific)	N/A	MILD STEEL	Freestanding	D/S on S/S	RPF 1.5	RP branding	RP brand motif + Department logo
RP-W 6B	DBCA	PRIMARY SITE ID SIGN	Vehicles	Site Name (Site Specific) Regional Park Name (Park Specific)	N/A	MILD STEEL	Freestanding	D/S on S/S	RPF 1.5	RP branding	RP brand motif + Department logo
RP-W 7A	DBCA	SECONDARY ENTRY SIGN	Pedestrians	Regional Park Name (Park Specific) Site Name (Site Specific)	N/A	MILD STEEL	Freestanding	D/S on S/S	RPF 1.4	RP branding	RP brand motif + Department logo
RP-W 7B	DBCA	SECONDARY SITE ID	Pedestrians	Site Name (Site Specific) Regional Park Name (Park Specific)	N/A	MILD STEEL	Freestanding	D/S on S/S	RPF 1.4	RP branding	RP brand motif + Department logo
RP-W 8A	DBCA	TRAIL MARKER	Pedestrians	Directional arrows mounted to direct two-way pedestrian traffic	Site Specific	MILD STEEL	Freestanding	D/S	RPF 5.3 + arrows	RP branding	N/A
RP-W 8B	DBCA	TWO-WAY TOTEM POST	Pedestrians	Max of 4 x 150mm x 150mm symbols (Use RP Symbols Index / Risk Symbol Index) on 2 sides of post	N/A	MILD STEEL	Freestanding	D/S on S/S	RPF 5.1 + max of 4 x 150m x 150mm symbols on 2 sides	RP branding	RP ID symbol* See RP Symbol Index
RP-W 8C	DBCA	THREE-WAY TOTEM POST	Pedestrians	Max of 4 x 150mm x 150mm symbols (Use RP Symbols Index / Risk Symbol Index) on 3 sides of post	N/A	MILD STEEL	Freestanding	S/S D/S on 3 Ss	RPF 5.2 + max of 4 x 150m x 150mm symbols on 3 sides	RP branding	RP ID symbol* See RP Symbol Index
RP-W QA	DBCA	BOUNDARY SIGN (BOUNDARY CORNER)	Vehicles	Regional Park Name (Park Specific)	N/A	MILD STEEL	Freestanding	D/S	RPF 2.4	RP branding	Department logo
RP-W 9B	DBCA	BOUNDARY SIGN (BOUNDARY EDGE)	Vehicles	Regional Park Name (Park Specific)	N/A	MILD STEEL	Freestanding	S/S	RPF 3.7	RP branding	Department logo
RP-W 9C	DBCA	BOUNDARY PATH SIGN	Pedestrians	Regional Park Name (Park Specific) Site Name (Site Specific) + (Optional) 4 x Symbols	N/A	MILD STEEL	Freestanding	S/S	RPF 3.1	RP branding	Department logo
RP-W 9D	DBCA	SITE ID + BOUNDARY PATH SIGN	Pedestrians	Site Name (Site Specific) Regional Park Name (Park Specific) + (Optional) 4 x Symbols	Site Specific	MILD STEEL	Freestanding	s/s	RPF 3.1	RP branding	Department logo
RP-W 9E	DBCA	BOUNDARY FENCE SIGN	Pedestrians	Regional Park Name (Park Specific)	N/A	MILD STEEL	Mounted	D/S	800x400 (mm) sign plate	RP branding	Department logo
RP-W 9F	DBCA	BOUNDARY & DIRECTIONAL SIGN	Pedestrians	Regional Park Name (Park Specific) + Site name (Site Specific) Destination Name + Direction Arrow + Distance to	Site Specific	MILD STEEL	Freestanding	D/S on S/S	RPF 1.2/ RPF 2.2	RP branding	Department logo

Management Signs and Sign Frames

Regional Parks Sign List

NO	AUTHORITY / APPROVAL	SIGN TITLE	AUDIENCE	SIGN CONTENT (COPY)	SIGN FRAME MATERIAL	SIGN FRAME DETAILS	SIGN FRAME	SIGN SIZE (MM)	SIGN MATERIAL	FIXING METHOD	COLOUR	LOGOS / CORPORATE IDENTITIES
RP-M	DBCA	TEMPORARY SYMBOL SIGN	Pedestrians	Temporary management sign - requirement specific	MILD STEEL	Freestanding	RPF 1.1	M3: 400x300	ALUMINIUM	with cable ties	RP branding + Symbols - as per RP Symbol Index	RP brand motif + Department logo
RP - M3	DBCA	MANAGEMENT SIGN	Pedestrians	Management sign - Key issue / requirement specific	MILD STEEL	Freestanding	RPF 4.1 OR Unistruts on reverse mounted on to galvanized poles with caps	M3: 400x300	ALUMINIUM	with spacers OR w/ brackets for unistruts	RP branding	RP brand motif + Department logo
RP - M4	DBCA	MANAGEMENT SIGN	Pedestrians	Management sign - Key issue / requirement specific	MILD STEEL	Freestanding	RPF 4.2 OR Unistruts on reverse mounted on to galvanized poles with caps	M4: 600x450	ALUMINIUM	with spacers OR w/ brackets for unistruts	RP branding	RP brand motif + Department logo
RP - M5	DBCA	MANAGEMENT SIGN	Pedestrians	Management sign - Key issue / requirement specific	MILD STEEL	Freestanding	RPF 4.3 OR Unistruts on reverse mounted on to galvanized poles with caps	M5: 800x600	ALUMINIUM	with spacers OR w/ brackets for unistruts	RP branding	RP brand motif + Department logo

Visitor Risk Signs and Sign Frames

NO	AUTHORITY / APPROVAL	SIGN TITLE	AUDIENCE	SIGN CONTENT (COPY)	SIGN FRAME MATERIAL	SIGN FRAME DETAILS	SIGN FRAME	SIGN SIZE (MM)	SIGN MATERIAL	FIXING METHOD	COLOUR	LOGOS / CORPORATE IDENTITIES
RP-R	DBCA - VRM	VISITOR RISK SIGN	Pedestrians	As per Hazard Risk Manual	MILD STEEL	Freestanding	existing	R1: 400x300	ALUMINIUM	with spacers	as in Hazard Risk Manual	Department logo
RP-R1 RP-R3 RP-R4	DBCA - VRM	VISITOR RISK SIGN	Pedestrian / Vehicle * *800mm x 600mm only is for vehicles	As per Hazard Risk Manual	ALUMINIUM	Freestanding	Unistruts on reverse mounted on to galvanized poles with oaps as per Hazard Risk Manual	R1: 400x300, R3: 600x450, R4: 800X600		with brackets for unistruts	as in Hazard Risk Manual	Department logo

NOTE: ALL FRAMES ARE MEANT TO BE S/S ONLY

32

Interpretive Signs and Sign Frames

Regional Parks Sign List

NO	AUTHORITY / APPROVAL	SIGN TITLE	AUDIENCE	SIGN CONTENT (COPY)	SIGN FRAME MATERIAL	SIGN FRAME DETAILS	SIGN FRAME	SIGN SIZE (MM)	SIGN MATERIAL	FIXING METHOD	COLOUR	LOGOS / CORPORATE IDENTITIES
RP IP-1	DBCA	TRAILSIDE / INTERPRETIVE SIGN	Pedestrians	Sign Specific Copy to be developed (site specific) and supplied to Design Studio w/ accompanying imagery/artwork	MILD STEEL	Freestanding	RPF 4.1 or PG31 inclined	IP-1: 400x300	ALUMINIUM	w/ spacers	RP branding	RP brand motif + Department logo
RP IP-2	DBCA	TRAILSIDE / INTERPRETIVE SIGN	Pedestrians	Sign Specific Copy to be developed (site specific) and supplied to Design Studio w/ accompanying imagery/artwork	MILD STEEL	Freestanding	RPF 4.2 or PG32 inclined	IP-2: 600x450	ALUMINIUM	w/ spacers	RP branding	RP brand motif + Department logo
RP IP-3	DBCA	TRAILSIDE / TRAILHEAD / INTERPRETIVE SIGN	Pedestrians	Sign Specific Copy to be developed (site specific) and supplied to Design Studio w/ accompanying imagery/artwork	MILD STEEL	Freestanding	RPF 4.3 or PG33 inclined	IP-3: 800x600	ALUMINIUM	w/ spacers	RP branding	RP brand motif + Department logo
RP IP-5	DBCA	TRAILHEAD / INTERPRETIVE SIGN	Pedestrians	Sign Specific Copy to be developed (site specific) and supplied to Design Studio w/ accompanying imagery/artwork	MILD STEEL	Freestanding	RPF 4.5 or PG36 inclined	IP-5: 1600x600	ALUMINIUM	w/ spacers	RP branding	RP brand motif + Department logo
RP IP-4 ~	DBCA	INTERPRETIVE SIGN	Pedestrians	Sign Specific Copy to be developed (site specific) and supplied to Design Studio w/ accompanying imagery/artwork	MILD STEEL	Freestanding	PG35 plaza	2 x IP-4: 900x1200	ALUMINIUM	w/ spacers	RP branding	RP brand motif + Department logo

Sign orders and installation

Process

The Regional Park signs are not D.I.Y signs. The sign plates are designed by the Design Studio to meet Corporate standards and the sign frames are to be manufactured by professional sign manufacturers to the specifications outlined in this manual.

The ordering and production process differs according to the sign type. It is important that you read the following AND refer to the relevant section for details relating to each sign type.

1. Sign frame orders

All sign frames and vinyl wraps must be ordered through the Design Studio using the correct order form. It is recommended that sign frames be ordered first before the vinyl wrap to ensure it is the best fit.

All vinyl wraps for existing sign structures must also be ordered through the Design Studio. In the case of vinyl wrapping an existing structure, check the frame measurements on site and record dimensions exact to the millimetre on the order form. Incomplete order forms will not be processed within the Design Studio.

Manufacture Supervision

Inspect signs and structures in the workshop after manufacture but prior to acceptance. Any damage must be brought to the attention of the manufacturer as soon as possible, and replacements must be ordered if necessary.

2. Sign plate orders

(for sign plates attached to poles or frames without vinyl wrap)

- Main Roads signs (RP-MRWA 1, RP-MRWA 2) order through Main Roads WA.
- Symbols (150 x 150mm; 250 x 250mm) order directly from preferred sign suppliers: Jason Signmakers / Compac Marketing.
- Visitor Orientation, Management and Visitor Risk signs submit an order form to the Design Studio Coordinator.
- Interpretation signs contact the Interpretation, Marketing and EMedia Unit Coordinator for guidance on developing your interpretation signs. When you are ready to order the signs then send the completed IP-5 Interpretation Order Form with all digital content (text, images, graphics, logos) to the Design Studio Coordinator.

Order forms

Use the correct order forms when ordering signs and remember to include any measurements that are not standard as set out in this manual. Refer to the Key Resources Folder/Page or contact the Design Studio Coordinator for a copy of the correct order form.

Sign orders and installation

Process

3. Pre-production Approval

For all orders that go through the Design Studio, the Regional Manager will be provided with an Expense Sheet (Quote) and Approval Form. All sign orders must be authorised by the Regional Parks Manager before the signs go to production. If you are not a staff member with the department and would like to install signs in accordance with standards outlined in this manual, please contact the Design Studio Coordinator to obtain a copy of our easy-to-use templates.

4. Sign plate delivery and quality control

The warranty for damage and defects has an expiry date, so check your completed signs for damage or flaws as soon as they are delivered. This is especially important if there is a delay in installing them and they are to be stored in the meantime. Report any damages and defects with photographic evidence and revelant job numbers (refer to approval forms) to the Design Studio Coordinator or with relevant quote numbers to the sign company (for direct orders).

5. Frame and Sign plate installation

Refer to your sign plan to ensure signs are placed in the correct location and correct orientation. Refer to drawings in this manual for details of installation standards (e.g. heights and footings).

Site clearance

Prior to installation, it is important that you have checked the proposed location for each sign to ensure it is suitable, i.e. check for underground or overhead services, land tenure, and where necessary gain approvals from local government or Main Roads WA.

Installation by manufacturer

Provide clear instructions, plans and drawings to the sign manufacturer if they are installing the signs. Ensure access is arranged for them. Ideally have a Regional Parks Unit staff member on site to supervise installation of the signs to ensure correct placement, height and material requirements.

Check off all frames and signs after installation promptly in order to assess condition prior to any potential tampering. If a defect or damage is found, take photographs. Put in a report on the defect with appropriate supporting documentation with the Design Studio (if ordered through them) or the manufacturer (if ordered directly).

Sign orders and installation

Wayfinding Signs RP - MRWA

State roads, consisting of freeways, highways and other major roads, provide a key link for motorists accessing tourist attractions throughout the State. These tourist attractions will either have direct connection to a State road, or will be accessed via a local government road which in turn directly or indirectly connects with a State road.

RP-MRWA 1 and RP-MRWA 2

In 2003, Main Roads WA approved the directional signs RP-MRWA 1 and RP-MRWA 2, which marry the Main Roads sign guidelines with the Regional Parks sign system. In Policy and Application Guidelines - Tourist and Service Signs in Western Australia (Main Roads WA, Oct 2016), RP-MRWA 1 and RP-MRWA 2 are classed as Tourist Feature signs.

Tourist features are primarily based on natural attractions and include national parks, scenic lookouts, waterfalls, rock formations, caves, dams, etc. and where applicable, are operated by a State-owned entity on a non-commercial basis.

Sign Type and Placement

RP-MRWA 1 is a chevron direction sign that has been designed for use on State roads at or directly opposite the point of entry to a Regional Park. It combines the park name and branding with a direction and distance to a specific site or tourist feature within the Regional Park.

RP-MRWA 2 is a fingerboard sign for use where the point of entry to a site or tourist feature is accessed via a local government road.

Responsibilities for Tourist Feature Signs Signs on State Roads

The cost of installing and maintaining signage on State roads shall be met by Main Roads. Main Roads shall be responsible for carrying out the installation and maintenance of signs on State roads, and retains ownership of the signs.

Signs on local government roads

The cost and task of installing and maintaining signage on local government roads shall be met by the LGA. The LGA is responsible for carrying out the installation and maintenance of signs on local government roads, and retains ownership of the signs.

Sign orders and installation

Wayfinding Signs RP - MRWA 2

When a RP-MRWA 1 or RP-MRWA 2 is required, the following steps should be followed:

Step 1

Identify the type of sign and preferred location on a sign plan, and have that approved by the department's Regional Parks Manager as part of the departmental sign planning process.

Step 2

Apply for the new or replacement sign directly to the LGA responsible for the municipality in which the Regional Park is located. Applications forwarded directly to Main Roads will be redirected to the LGA. In the application include details of the park branding appropriate to that Regional Park i.e. a full colour copy of the relevant sign drawings from the Regional Parks sign manual, colour specifications and motif specifications. For RP-MRWA 1, include motif size, which depends on the speed limit of the road. Two motif sizes are available (300mm² or 500mm²).

Step 3

Following assessment by the LGA, a written application shall be forwarded, (by either the LGA or applicant directly), to Main Roads' Traffic Technical Services Manager in the Perth metropolitan area, or to the appropriate Regional Manager in regional areas. The application shall include a written statement from the LGA confirming that the application has been assessed as meeting the relevant conditions for signing and that it complies with tourist signage.

Note: An LGA application can take 3 to 8 weeks depending upon the council meeting dates and size of the agenda.

Step 4

Liaise with the LGA and/or Main Roads to confirm sign approval and the production process. This may require the department to order the sign directly from the Main Roads approved sign manufacturer.

Step 5

Determine a schedule for installation by Main Roads. Regional Park staff to check and sign off the sign as part of the project management process after installation.

Sign orders and installation

Ordering Management Signs

All management signs must be ordered through the Design Studio and must comply with departmental standards.

Step 1

Identify the management issues with the park. Do not address more than one management issue on a sign. Keep your messages simple.

NOTE: The Design Studio has copies of management signs previously produced and can pass on examples to assist with wording and symbols appropriate to specific topics/issues.

Step 2

Identify other components of the layout such as a suitable illustration and employ the use of symbols, where possible, so the gist of the sign content can be understood by a visitor who's first language isn't English. Illustrations and/or photographs provide a visual impact to signage and attract the viewer's eye. Ensure they support your content copy.

Step 3

Any job submitted must use the M3-8 Management Sign Order Form and include pre-approved text and graphic elements to the Design Studio's minimum specifications. The Design Studio Coordinator will then assign it to a designer in-house.

Step 4

When the draft layout is designed, it will be sent back to the originating officer for comment or approval along with associated costs for production of the sign plate.

Step 5

Once the layout is approved, the final design is sent back to the originating officer for sign-off along with appropriate documentation to initiate production.

Departmental Standards for sign layout

They follow the 1/3rd principle design rule for sign layout and therefore have set word limits for each type of sign plate size as listed below.

Sign plate size in mm	Word limits	
400 x 300	60 words	
600 x 450	80 words	
800 x 600	150 words	

Installation of signs

Refer to the Installing sign plates page for more information.

Installation Safety Procedures

All regional park safety procedures as set by the department are to be observed during installation procedures.

Sign orders and installation

Ordering Risk Signs

All risk signs **must be** ordered through the Design Studio and **must comply** with the department's Hazard Sign Manual. They **must** also be **approved by the Visitor Risk Management (VRM) Coordinator** as part of this process. They must adhere departmental standards for sign layouts, refer to the previous page for word limits.

Step 1

All visitor risk copy (text) is site-specific. Identify the information that your risk sign needs to convey and send a draft risk sign copy to the Design Studio where it will be designed to meet the department's standards. All orders for risk signs must use the R1-R8 Risk Hazard Order Form. Refer to Key Resources Folder/Page for more information.

The Danger symbol and word is red cast vinyl-cut lettering. The text is black and the symbols (depicting the risk) are black on yellow, digitally printed onto Class 2 Reflective white cast vinyl as outlined in the Hazard Sign Manual.

NOTE: The Design Studio has copies of risk signs previously produced and can pass on examples to assist with wording and symbols appropriate to specific risks.

Step 2

The draft design is then submitted to the VRM Coordinator for comment/approval and recommended changes are made if necessary.

All risk signs must be approved by the VRM Coordinator via the department's Design Studio prior to print production.

Step 3

Once approval is gained, the final design is sent back to the originating officer for sign-off along with appropriate documentation to initiate production.

Installation of signs

All risk signage is to be mounted with unistruts and brackets onto galvanised poles in accordance with the guidelines set in the department's Hazard Sign Manual.

If a new sign is to be mounted onto an existing structure, approval must be obtained from the department's VRM Coordinator prior to production.

Installation Safety Procedures

All regional park safety procedures as set by the department are to be observed during installation procedures.

Sign orders and installation

Ordering Interpretive Signs

Interpretation signs inform, entertain and inspire visitors about natural and cultural values and experiences. They are designed to provoke visitor's thoughts and feelings in a way that relates to the visitor's lifestyle and life experiences.

Interpretation is an art that requires professional consultation, planning, design and evaluation. Staff from the Interpretation, Marketing and EMedia Unit can assist you with sign planning, including the selection, sequencing and placement of the interpretive signs, and with content development.

STEP 1

Check if an interpretation plan or designs for interpretive signs relevant to your park already exist.

STEP 2

Prepare an analysis of the sites, stories, visitors and issues to be addressed by interpretive signs. Contact the Interpretation, Marketing and eMedia Unit Coordinator for guidance.

STEP 3

Identify specific site and story opportunities and choose suitable interpretive sign installations and templates to tell those stories from the Sign List.

STEP 4

Draft the copy (text) to suit the templates and stories selected (i.e. consider style and word count) and gather high quality, digital graphics (photographs or artwork). If you are including artwork, prepare an art brief for the artist, for example by providing them with appropriate photographs of park features and wildlife.

STEP 5

Send a draft copy to the department's Interpretation, Marketing and eMedia Unit Coordinator for review, editing and approval. Any job submitted must use the IP1-5 Interpretive Sign Order Form and include pre-approved text (word limits observed) and other graphic elements to the Design Studio's minimum specifications.

STEP 6

Provide cost codes to the Design Studio on the correct order forms.

Sign orders and installation

Ordering Interpretive Signs

Departmental Standards for sign layout

All sign layout must follow the 1/3rd principle design rule and therefore have set word limits for each type of sign plate size as listed below.

Sign plate size in mm	Word limits	
400 x 300	60 words	
600 x 450	80 words	
800 x 600	150 words	
900 x 1200	250 words	
1600 x 600	300 words	

Timeframe for Interpretation Signs

These signs require a much longer period for content development and graphic design, and have an earlier Design Studio deadline in the financial year than other types of signs. So, allow plenty of time for stakeholder consultation and content development and approval.

Note: For signs to be produced and paid for within a financial year, these jobs need to be logged in with the Interpretation, eMedia and Marketing Unit Coordinator by no later than the end of January.

Sign-free zones

Signs are one method of interpreting a site and sharing stories with visitors, however some sites speak for themselves. We do not have to physically interpret everything and we should aim to create a range of experiences including areas that are sign-free.

Other methods

Signs are not the only interpretive medium available to you. Other methods of communicating park values such as digital and print media or guided interpretive activities may be more appropriate or effective for your situation than a static sign display.

For advice and guidance on communication options, and the planning and development of interpretive facilities and services, please contact the department's Interpretation, eMedia and Marketing Unit Coordinator.

Sign installation

Installing sign plates

Sign plates mounted onto RPF Series 4/5 **must** employ the use of spacers. Aluminium sign plates can react with the mild steel frame if in direct contact and over time this quickens the deterioration of the sign frame and shortens its life span. See images of sign frame damages over time.





Recommended process to prevent contact between the two metals If the mild steel surface is brand new then it should be easy to clean and attach the sign plate. If the surface is already rusted then remove the rust with a wire brush and either clean with methylated spirits OR paint with a rust-destroying primer.

The aluminium sign plate can then be attached using the double-sided tape, which will prevent the two surfaces from touching. The rust will form around the tape but not between the tape and the backing plate, so it should remain secure for a long time.



Spacer - industrial strength double-sided adhesive tape used to mount sign plates to frames creates a narrow space that separates the two metals.

If installing using galvanised poles with caps, ensure that the sign plates are ordered with appropriate number of unistruts on reverse, order the correct number of brackets and poles for the respective size. Ensure the sign is mounted at optimal height (base of the sign to be 650mm from the ground) for ease of readibility of sign.

Installation Safety Procedures

All regional park safety procedures as set by the department are to be observed during installation procedures.

Sign installation

Installing vinyl wraps

Installation of vinyl wrap

Vinyl wrap installation is a two-person task and if undertaken by department staff, must be done under the supervision and direction of a Regional Parks Operations staff member, who has had considerable exerience in the vinyl wrapping process.


For more tips on the process of installing a vinyl wrap, a 'step-by-step guide to installing vinyl wraps' in available in your KEy Resource folder.

Alternatively the sign company can install the vinyl wraps on site (a quote must include and itemize this additional cost) This is a preferred option due the warranties that accompany a professionally installed product. Refer to the section on Vinyl Wraps.


Installation Safety Procedures

All regional park safety procedures as set by the department are to be observed during installation procedures.

Glossary of terms and measurements

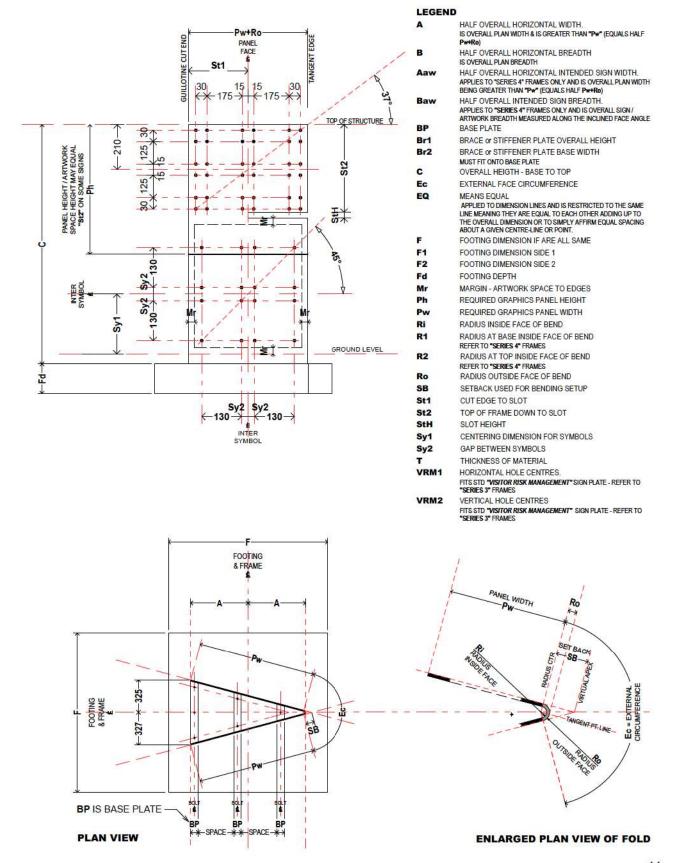


RPF Series 1

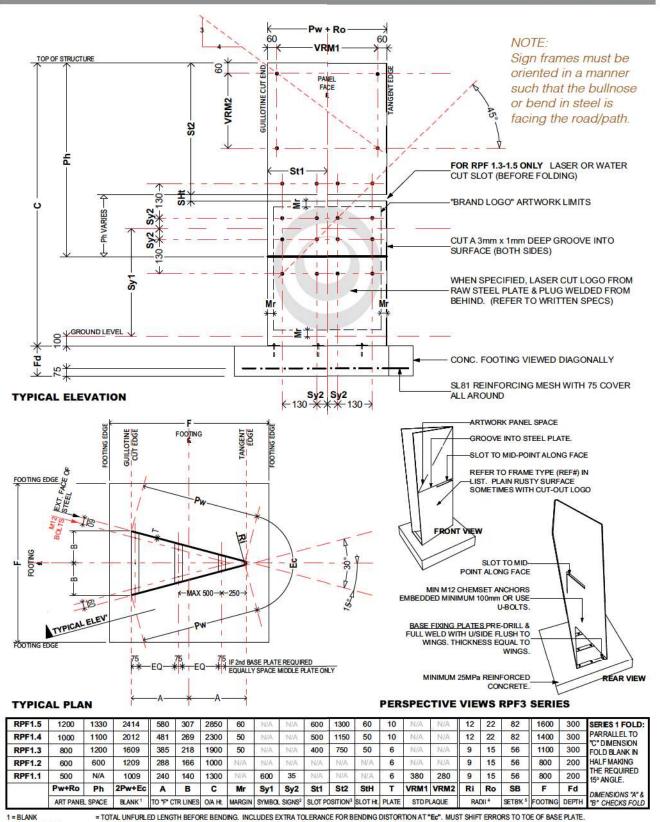

- 2 = SYMBOL SIGNS
- 3 = SLOT POSITION
- 4 = RADII 5 = SETB'K (=SETBACK)
- = TOTAL UNFURLED LENGTH BEFORE BENDING. INCLUDES EXTRA TOLERANCE FOR BENDING DISTORTION AT "Ec". MUST SHIFT ERRORS TO TOE OF BASE PLATE. = HOLE POSITIONS FOR SYMBOL SIGNS BASED ON A STD 150x150 PLAQUE WITH A 4.5mm HOLE IN EACH CORNER OFF SET 65mm FROM PLAQUE CENTRE LINES
- = SLOT'S END EXTENDS TO HALF THE OVERALL WIDTH MEASURED AS "Pw+Ro" ABOVE.
- = RADIUS TO OUTSIDE FACE (Ro) IS THEORETICAL & VARIES DUE TO DISTORTION CAUSED BY BENDING & IS NON-CONCENTRIC WITH INNER RADIUS (R).
 = STANDARD OFF-SET FROM BEND CENTRE TO NOTIONAL APEX WHERE THE OUTSIDE FACE PLANES MEET. (VARIED BY DESIGN IF RADIUS & MATERIAL THICKNESS CHANGES).


RPF Series 2

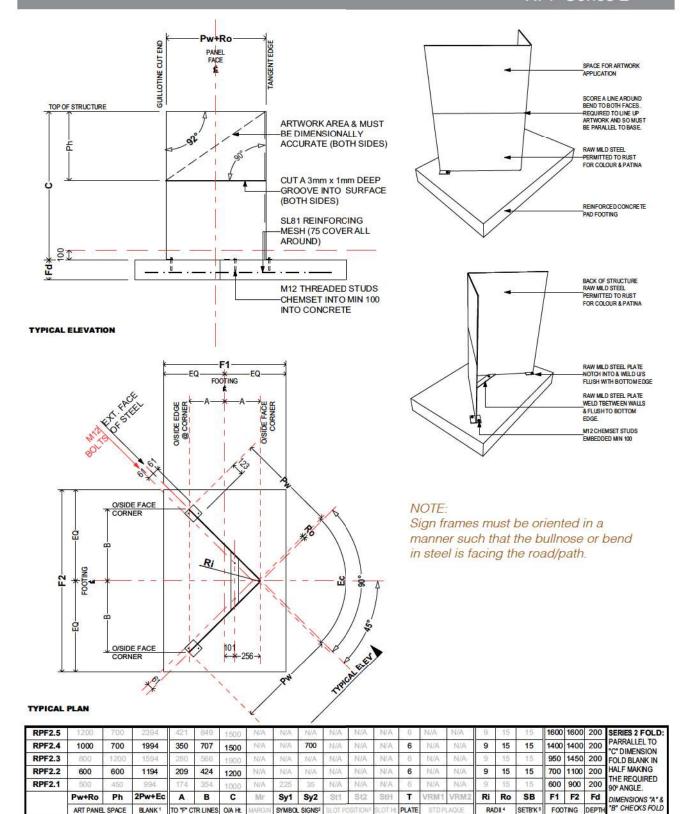

- 1 = BLAN 2 =SYMBOL SIGNS

- 4 = RADII 5 = SETBK (=SETBACK)
- TOTAL UNFURLED LENGTH BEFORE BENDING. INCLUDES EXTRA TOLERANCE FOR BENDING DISTORTION AT "Ec". MUST SHIFT ERRORS TO TOE OF BASE PLATE = HOLE POSITIONS FOR SYMBOL SIGNS BASED ON A STD 150x150 PLAQUE WITH A 4.5mm HOLE IN EACH CORNER OFF SET 65mm FROM PLAQUE CENTRE LINES
- = RADIUS TO OUTSIDE FACE (Ro) IS THEORETICAL & VARIES DUE TO DISTORTION CAUSED BY BENDING & IS NON-CONCENTRIC WITH INNER RADIUS (RI),
 = STANDARD OFF-SET FROM BEND CENTRE TO NOTIONAL APEX WHERE THE OUTSIDE FACE PLANES MEET. (VARIED BY DESIGN IF RADIUS & MATERIAL THICKNESS CHANGES).

RPF Series 3

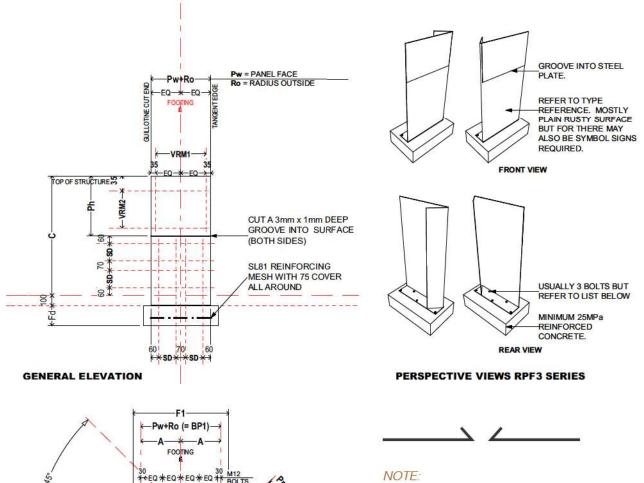

Sign frames must be oriented in a manner such that the bullnose or bend in steel is facing the road/path.

Orientation of sign frames for RPF Series 3 must be determined at sign planning stage. This consequently determines sign design layout and vinyl wrapping procedure.

	ART SP	ACE1	BLANK ²	Š	STD 4.5mi	m HOLES	i.	OVERA	LL DIME	NSIONS	BASE	PLATE	MAX SAP	CING 2704	PLATE	FOOTI	NG DIMEN	ISIONS	RADIN	& OUT 6	SETBACK
	Pw+Ro	Ph	Pw+Pr+Ec	VRM1	VRM2	Mr	SD	A	B4	C	BP1	BP2	Bs1 ⁵	Bs2 ⁵	T	F1	F2	Fd	Ri	Ro	SB
RPF3.1	450	450	615	N/A	N/A	N/A	N/A	225	64	1000	450	140	3M12	N/A	6	600	450	200	9	15	36
RPF3.2	450	N/A	615	380	280	25	N/A	225	64	1000	450	140	3M12	N/A	6	600	450	200	9	15	36
RPF3.3	500	N/A	665	380	280	60	130	250	64	1300	500	140	3M12	N/A	6	650	500	200	9	15	36
RPF3.4	600		765					300	84	1300	600	140	3M12	N/A	6	750	550	200	9	15	36
RPF3.5	800	0	965					400	64	1300	800	140	N/A	5M12	6	960	600	200	9	15	36
RPF3.6	900	6	1065			6 - 6		500	64	1300	900	140	N/A:	5M12	6	1000	600	200	9	15	36
RPF3.7	1000	700	1310	N/A	N/A	N/A	N/A	500	115	1500	1000	240	N/A	5 M12	6	1150	700	200	9	15	36

1 = ARTWORK SPACE

PLAN VIEW

PATTERN

IF 3 BOLTS

- 2=BLANK
- 3 = STANDARD HOLES
- 4 = B
- 5 = Bs
- 6 = RAD IN & OUT 7 = SETBACK
- = UNLESS SPECIFIED, SPACE FOR OTHERS TO TREAT & APPLY THE ARTWORK GRAPHICS.
 - = GEOMETRIC DIMENSION (THEORETICAL) WITH TOLERANCE FOR POSSIBLE DIMENSIONAL DISTORTION DUE TO THINNING IN THICKNESS AT "Ec".
 - = REQUIRED TO MATCH STANDARD HOLE PUNCHING BY SIGN MAKER & ALL HOLES ARE REQUIRED AS PART OF THE FABRICATION IF THE STRUCTURE TYPE REQUIES THE HOLES. = BREADTH DIMENSION "B" WHICH IS THE SIGN FRAME WIDTH ONLY EXCLUDING THE BASE PLATE (BP) WHICH IS WIDER. = BOLT SPACING NOTE THE PATTERN FROM 3 BOTS TO 5 BOLTS.

FOR 5 BOLTS

MOVE CTR


Ro BOLT

Bs1 or Bs2

- = NOTE THAT RADIUS TO OUTSIDE FACE (THEORETICAL) WILL VARY DUE TO DISTORTION CAUSED BY BENDING & IS NON-CONCENTRIC WITH INNER RADIUS (RI).

 = STANDARD OFF-SET FROM BEND CENTRE TO NOTIONAL APEX WHERE THE OUTSIDE FACE PLANES MEET. (VARIES IF RADIUS AND MATERIAL THICKNESS VARIES).


RPF Series 4

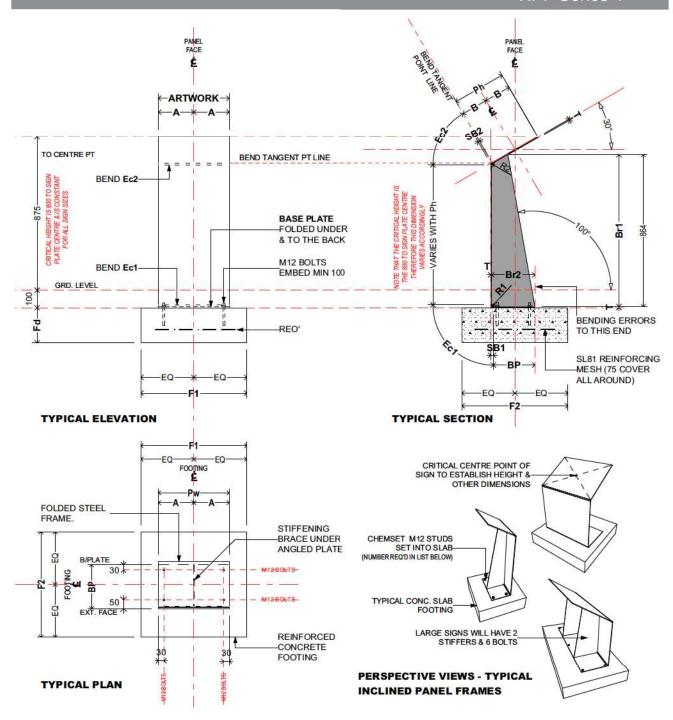

	ARTM	K O/A	BLANK LENGTH ²	TO "F" C	TRLINES	WIDTH	BRACE (S	TIFFENER)	PLATE		FOOTING		RAD O/S 4	RAD I	NSIDE	SETB	ACKS 5
	Pw ¹	Ph	W+EC1+H+EC2+2B	Α	B ³	BP	Br1	Br2	Т	F1	F2	Fd	Ro	Ri1	Ri2	SB1	SB2
RPF4.1	400	300	1372	200	150	250	864	244	6	600	600	200	15	9	9	15	9
RPF4.2	600	450	-1680	300	225	345	864	244	6	800	600	200	15	9	9	15	9
RPF4.3	800	600	1787	400	300	440	877	425	6	1000	1000	200	15	9	9	15	9
RPF4.5	1600	600	1787	800	300	440	877	425	6	1800	1000	200	15	9	9	15	9

- 1 = Pw
- 2 = BLANK LENGTH 3 = B
- 4 = RAD O/S 5 = SETBACK
- = PANEL WIDTH FOR ARTWORK & IS LENGTH OF SIGN MEASURED ACROSS THE FRONT. TO LERANCE MUST NOT BE LESS THAN THAT GIVEN TO ENSURE THAT SIGNS FIT.
- = TOTAL UNFURLED LENGTH BEFORE BENDS. INCLUDES EXTRA TOLERANCE FOR BENDING DISTORTION AT "Ee". SHIFT ERRORS TO TOE OF BASE PLATE. = NOT GIVEN ON THE PLAN, REFER TO THE SECTION. "A" & "B" CENTRES THE ARTWOK SPACE OVER THE FOOTING.
- = RADIUS TO OUTSIDE FACE (THEORETICAL) VARIES DUE TO DISTORTION CAUSED BY BENDING & IS NON-CONCENTRIC WITH INNER RADIUS (R INSIDE).
 = STANDARD OFF-SET FROM BEND CENTRE TO NOTIONAL APEX WHERE THE OUTSIDE FACE PLANES MEET. (VARIED BY DESIGN IF RADIUS & MATERIAL THICKNESS CHANGES).

RPF Series 5

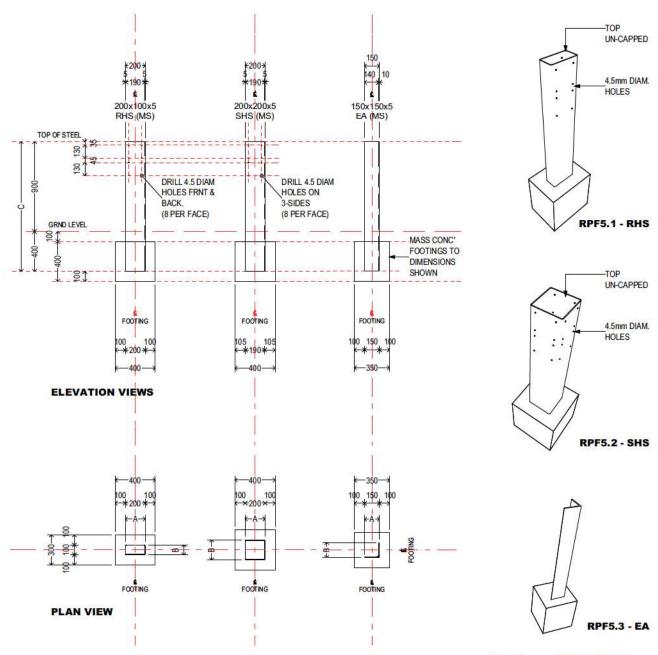

Sign frame RPF 5.3 must be oriented in a manner such that the bullnose or bend in steel is facing the pedestrian path.

3	A	В	С	Т	ABR'V	SECTION TYPE	IF NOT USING BLACK STEEL THEN SAND BLAST TO REMOVE ANY COATING. AVOID ANY CONTAMINATION THAT MAY RETARD EVEN RUSTING. IF SECTION SIZE OR WALL THICKNESS UNAVAILABLE THEN USE THE NEXT SIZE UP.
RPF5.1	200	100	1300	5	RHS	RECTANGULAR HOLLOW SECTION	FINISH SHALL BE AN EVEN WEATHERED RUSTY FINISH.
RPF5.2	200	200	1300	5	SHS	SQUARE HOLLOW SECTION	WITH HOLES WHERE NOTED.
RPF5.3	150	150	1300	10	EA	EQUAL ANGLE	THESE POSTS ARE FABRICATED FROM STANDARD MILD STEEL SECTIONS. PREPARE THEM

Sign Frames

Preliminary Clauses

When ordering sign frames directly through a sign company, all sign frame drawings must be supplied along with preliminary clauses, material specifications and if required, footing information as provided in this manual. For example, pages 50-53 in this manual must accompany a sign frame drawing at all times.

Proprietary Products/Consumable

Materials referred to by their retail product name are indicative only and have been named because availability and performance is known. Equivalent products by other suppliers may be considered by the department; however, it is the supplier's responsibility to provide enough proof for the department to make the decision.

Where proprietary products are used in sign production the contractor shall strictly adhere to the manufacturer's instructions and specifications.

Warranties

Provide to the client all warranties covering the specified periods in this contract for all proprietary consumables and finishes required.

Rejected supply

If a delivered sign does not satisfy the requirements of these specifications then it may be rejected by the client and payment withheld until it is replaced or suitably repaired to the client's satisfaction by the contractor.

Supply

It is the contractor's responsibility that all delivered signs are fabricated to look the same as their respective visual images in this sign manual as well as meeting all specifications herein and guarantee work quality to have produced a robust result.

Changes and Substitutions

The client has successfully built these sign structures in the past and is satisfied that supply as specified is achievable. In the interest of consistency and branding, the client is not soliciting proposals for changes.

Proposed changes that are completely based on commercial preference will not be considered.

Submit, for department approval, any proposed change or alternative material prior to ordering such materials or commencement of any work that includes such change.

Sign Frames

Preliminary Clauses

Instructions

All instructions relating to the signs beyond those included in this sign manual should only be acted upon if in writing and signed by the client.

Shop Drawings

Other than drawings and specifications herein, there are no additional detailed drawings. Produce shop drawings interpreting the drawings, specifications and instructions accompanying the purchase order of any given sign.

Shop drawings shall be submitted for approval by the client.

Shop drawings shall allow for review, amendment and re-submission before purchasing materials for this contract or commencing fabrication. The client takes no responsibility for pre-purchased materials which shall remain the contractor's responsibility.

Any amendments to the shop drawings shall be indicated by a "cloud" and shall be recorded as a revision, listing date and brief description on a suitable place on the drawing.

Sign Frames

Material Specifications

Alternative Materials

Alternative materials are not recommended nor solicited.

If specified materials are inappropriate for the site location or there is a supply issue that may cause a failure to deliver on the contract the client may negotiate "alternative materials" provided approval processes are satisfied.

The contractor shall submit for written approval by the department any "alternative material" proposed for the signs prior to commencement of any work involving the use of that material. This applies even if an agreement has been negotiated; the appropriate approval process must be completed.

Concrete

All concrete shall comply with AS3600. Use only ordinary "Type A" Portland cement for concrete. Do not pour concrete in temperatures exceeding 38 degrees. Standard concrete mix shall be minimum 20MPa preferably "Ready-mix" delivered to site. Do not use additives.

The mixing of the concrete on-site, whether using raw materials or bagged "Dry-mix", shall be as per manufacturer's instructions provided on the cement or "Dry-mix" bags.

Steel

At minimum use a common G250 grade Mild Steel where steel is required. Other grades are acceptable but avoid mixing the grades in a sign. All steel used for Regional Parks signs shall be new mild-steel in a raw unprocessed form free from surface treatment, imperfections and defects including but not limited to oil stains, scratches and deformation.

In the finished sign product the steel will remain untreated, except as specified to accept graphics content and therefore shall be handled with care throughout the fabrication process.

Use rolled sections such as angles, square hollow sections (SHS) or Rectangular Hollow Sections (RHS) where there is an exact fit.

Welds

Welds shall comply with AS3679.1

Welds shall not be visible on the presentation faces of the sign and if necessary shall besuitably finished to match general surface appearance. All welds shall develop the full strength of members joined. Welds shall be minimum 6mm fillet welds or the thickness of thinnest material being joined.

Sign Frames

Footing

Footing Installation

Footing details and sizes are found in the relevant type of sign frame drawing.

Placement

Refer to landscape drawings or sign plans for sign locations. No vegetation shall be removed unless approved by the department.

If a footing placement conflicts with or compromises other existing site elements, including trees, the conflict shall immediately be referred to the client for further instruction. It is advised that double checking will be in the best interest of a favourable outcome.

Otherwise, where a footing is in conflict or within a constrained space then the decision to proceed shall consider the following:

- i. Will the larger part of the proposed footing's dimensioned shape and area be maintained?
- ii. Will no intended dimension be less than 70%?
- iii. Will the intrusion into the footing conflict the sign's base plate fixing bolts?
- iv. Will any intrusion compromise the minimum requirements (clearances) for cast-in base-plate holding-down assemblies?
- v. Ensure that the total volume of concrete, calculated from the detailed drawings, will still be provided and that the footing can be made deeper.

Locate each footing centrally under the sign.

Engineering

Footing sizes have been approved by a structural engineer and shall not be varied. Typical footings have been designed assuming Swan Coastal Bassendean sands. The boxed out preparation for all footings shall comply with 8 Blows per 300mm using a standard penetrometer calibrated for Swan Coastal Bassendean sands.

When preparations are unable to satisfy these requirements immediately inform the client for further Instruction. Install all concrete footings in accordance with the relevant Australian Standards.

Reinforcement

Steel reinforcement to each footing shall be Y12-250EW as a minimum, with 75mm all around cover. Where proposed, check that cast-in "U-Bolts" or ferrel type anchors for sign installation, are accommodated by the minimum footing dimensions. If inadequate, enlarge the footing as required to achieve minimum 100mm edge clearances and reinforcement cover stated above.

Sign Frames

Maintainence

Rusted Metal

Installed Mild steel for the signs are specified to be in "as is" raw state. They are intended to rust naturally in the environment. Development of the desired patina will be a gradual process dependent upon weather conditions and the condition of the atmosphere.

Ensure that the surface is not compromised by substances or materials that will impede the process.

Scratches in Metal

Only remove if the message is offensive with a grinding machine in situ and allow fresh area of metal to rust naturally.

Otherwise allow rusting over in time. It is appropriate to the design of the signs to be allowed to carry a "wear and tear" look.

Paint/marker Application

Remove with solvent and thoroughly clean-off any residue.

Painted Section

Maintenance action is dependent upon the degree of damage or the content of damage e.g offensive language.

Once determined that the damage is severe enough for maintenance prepare the surface for the installation of a new vinyl wrap. Refer to the section on vinyl wraps.

Self-Adhesive Lettering

All damages to self-adhesive lettering will be treated with a new vinyl wrap to the sign structure.

Anti - Graffiti coating

In the event of heavy vandal attack to particular signs, or where repeated vandal attack occurs, anti-graffiti coatings can be applied to the sign plate.

A UV overlaminate is applied to a vinyl wrap in lieu of anti - graffiti coating prior to install. Damages to these protective surfaces requires a new vinyl-wrap or new sign plate.

Scratches in Aluminium

Aluminium can be scratched. This cannot be removed but will not be highly evident due to solid colour of the material showing through.

Replace the complete sign when markings have become offensive or numerous.

Sign Frames

Maintainence

Concrete

Remone paint/marker graffiti: with solvent. Difficult marks can be removed with an air pressure solvent. To be completed by a professional company.

Scratches in Concrete

If required, sandblast to remove marks if offensive. Attempt to do a light blasting but will probably have to sand blast the whole area. To be completed by a professional company.

Fixtures

Any fixtures that are be removed should be replaced as soon as possible with the same item as specified for that particular sign type.

If an existing sign structure has faced reasonable wear and tear and replacement is being considered, it may be possible and cheaper to only replace the sign face.

Vinyl Wrap Proposition

Viny wrapping is an application proposed for on-site repair to existing signs to avoid the cost complexity of sign removal and repair at a remote site before reinstallation.

New sign structures can also be vinyl wrapped. This will allow consistency in colour throughout a site, given the anomalies of digital printing.

Vinyl Wrap

Ordering

For an existing sign frame

- i. Use the correct order form when ordering a sign. Refer to the sign structure number RP W xx when using order forms.
- ii. If ordering multiples of the same sign type, use the corresponding bulk order form. When using the bulk order form for that respective sign type, ensure you have noted the location of each sign and have a number associated that matches its location on the site map or sign plan.
- iii. Fill in the required information eg proposed wording,
- iv. Note accurate measurements (in precise millimetres) of the area to be covered by the vinyl wrap. This measurement needs to be done on site to ensure that the wrap takes into account the bend in the steel. Discrepancies can exist in the bend of the mild steel. Noting any of these discrepanies in measurements ensures that the new vinyl wrap accurately fits the existing structure. Double check your measurements to save the cost of reprinting.
- v. When ordering vinyl wraps for single-sided sign frames (RP-W 9B, 9C or 9D), the orientation of the sign frame must be determined during the sign planning stage. Ensure that the correct orientation is noted on the order form. This orientation determines the layout of the sign and will determine your vinyl wrapping process.

For a new sign frame

To ensure the new vinyl wrap accurately fits the new sign frame, the vinyl wrap must be ordered after the sign frame has been produced.

Order sign frame first through the sign company. Refer to section on Sign Frames for the detailed drawings and measurements of the different types of sign frames. Provide the drawing with exact dimensions highlighted to the sign company for the production of the sign frame.

Discrepancies can still exist between the measurements specified on the detailed drawing and the actual sign frame, once produced. To remeasure the new sign frame, follow the same procedure (as in step iv above) and record on the correct relevant sign order form.

In-house Production & Ordering Process

The Design Studio will design the layout and get quotes for the production. A package of layout and pricing will be sent to the district for approval prior to placing the order for production.

The final draft layout of the sign must be truthed on-site for accuracy and orientation.

Vinyl Wrap

Design and Production

Copy (text) for vinyl wraps may be through the department's in-house Design Studio or the LGA's approved Design Studio but must go through the department's in-house approval process before being sent to a sign company for printing.

Every vinyl wrap has two components to it: peelable backing sheet to protect the self-adhesive layer + digital print on cast vinyl with a UV overlaminate in lieu of a two-part anti-graffiti spray.

Every sign frame must be vinyl wrapped professionally, by either a sign company or sign (company recommended) installer. This is highly recommended due to the warranties that accompany a professionally installed product. Any flaws during an install process can then be rectified with no further expense to the department.

Engaging contracted sign company (third party)

The quote request will include an installation cost as a separate itemised component. Vinyl wrapss will be produced by the sign company and installed on site by the sign installer.

Prior arragements must be made for the sign installer to meet with Regional Parks Operations staff on site. If multiple signs are to be vinyl wrapped, it is preferable that the Operations staff guide the installer through the process, to ensure the new vinyl is matched accurately to the sign frame is was originally designed for. This may involve a few hours in the day depending on the number of sign frames in a park getting refurbished.

Surface preparation work completed by the department staff will be subject to approval by the installer to ensure that warranty is not voided. See our Step-by-step Guide to Vinyl Wrapding to ensure that preparation work done on the existing sign frame is adequate and to prescribed standards.

Vinyl Wrap

Application

Vinyl wraps done by a contracted sign company or third party must be checked by Regional Park Operations staff **before payment**. Any issues must be recorded in a detailed report (including photographs). If the wrapping is unacceptable, it must be re-printed and re-wrapped at the contractor's expense.

Vinyl wrapping that doesn't fit to the edge or isn't trimmed neatly to the edge of a sign frame is not to the department's prescribed standards and must be documented in a report back to the sign company as well as the Design Studio.





Ensuring departmental standards:

All vinyl wrap layouts shall be produced by the department's Design Studio (or the LGA's nominated design studio using the department's templates) to ensure current standards with regard to lettering sizes, logos, colour and layout.

To order a vinyl wrap via the Design Studio, use the department's wayfinding sign order forms. If engaging an external design studio, contact the Design Studio Coordinator for more information and our easy-to-use templates.

Purchasing Policy

Step 1

The department currently has a Tender for all sign plate sizes listed in this manual. All sign plate orders that fall within this specification therefore, must come through the Design Studio.

Step 2

All vinyl wraps for existing sign frames need to also come through the Design Studio. The Studio will obtain quotes for these jobs.

Step 3

All new signs (vinyl wraps as well as sign frames), depending on quantities required, may require a written quote or even a Tender based on the department's purchasing policy. For more information or current advice, check with your regional admin staff member or the department's Procurement Manager, Goods and Services.

Step 4

All new signs must be passed for workmanship and adherence to specifications by the Regional Parks Project Manager prior to their acceptance from the manufacturer. Regional Parks Operations Officer needs to be present during the installation of the sign structures on site.

Step 5

Signs must only be stored in an appropriately secure place, not on site.

Key Resources

Symbols

Symbols to be used on any Regional Park sign frame or totem, must adhere to the department's standards as outlined in the following key documents:

- 2018 Regional Parks Symbol Index
- DBCA Risk Symbol Index

Using these guides and the correct reference numbers in them, staff can now order symbols directly from the nominated sign companies. Ensure that you order the correct size: 150x150mm for pedestrians, 250x250mm for vehicles.

The department has provided Jason Signmakers and Compac Marketing thertwork for ordering symbols for use in all regional parks within the Perth Metropolitan region.

Manuals and planning tools

The department has, over time, developed, some effective information manuals and tools that may aid in sign planning and communicating with the visitors in Regional Parks. These include:

- Regional Parks Communication Strategy (2003)
- Interpretation plans for Regional Parks (2003) for Herdsman Lake Regional Park, Canning River Regional Park and Yellagonga Regional Park
- 2015-Parks-Wildlife-Hazard-Manual 1stRevision
- Sign Planning Exercise Workbook Blank worksheets for each of the signs types are provided. These can be downloaded, printed out and used on site for on-ground sign planning exercises and truthing sign plans and sign layouts.

Sign Frames

Regional Park sign frame drawings have been provided in this manual. However alternative (selective) sign frames from the department's sign system can be used:

Sign frames drawings for PG31, PG32, PG33, PG35 and PG36

Design Studio Order Forms

To log jobs into the Design Studio, download, complete and send in the correct order forms along with supporting material for sign design and layout.

- To order vinyl wraps for new or existing structures, use the Regional Parks Sign Order Form corresponding to the matching orientation sign type.
- To order sign plates for Risk, Management and Interpretive Signage, use the department's order forms based on the correct sign category.

Other Communications

This manual provides guidelines for departmental standards in signage across all regional parks.

Publications

All queries for print publications such as brochures, flyers, posters, booklets, invitations, stickers, banners etc. must be directed to the Public Information and Corporate Affairs Branch on (08) 9219 9814 or email publishing@dbca.wa.gov.au

Regional Park staff can access several helpful tools on the department's intranet page that assist in planning for publication requests prior to submitting a request.

Pre-visit information

The department's *ExploreParks* page provides pre-visit information online, along with any relevant park brochures for download. It is important to check this information for relevance and edit, if required, for accuracy.

To update or modify any pre-visit information use the online form on the intranet or email support@parksandwildlife.freshdesk.com

Confidentiality & Ownership

This document (together with any information made available to a manufacturer) is strictly confidential, it shall not be copied or distributed without approval from The Department of Biodiversity, Conservation and Attractions.

Department of Biodiversity, Conservation and Attractions Contacts

Regional Parks Unit Manager

Cnr Australia II Drive and Hackett Drive, Crawley WA 6009 Phone (08) 9442 0300. or email regional parks@dbca.wa.gov.au

Interpretation, Marketing and eMedia Unit Coordinator

Visitor Communications and Marketing Branch,
Parks and Visitor Services Division
17 Dick Perry Avenue, Kensington WA 6151
Phone (08) 9219 8580 or email interpretation@dbca.wa.gov.au

Design Studio Coordinator

Public Information and Corporate Affairs Branch, Corporate and Business Services Division 17 Dick Perry Avenue, Kensington WA 6151 Phone (08) 9219 8578 or email signstudio@dbca.wa.gov.au

Recreation, Planning And Design Coordinator

Parks and Visitor Services Division
17 Dick Perry Avenue, Kensington WA 6151
Phone (08) 9219 8420 or email Nathan Greenhill@dbca.wa.gov.au

Appendix A

Is a sign the answer?

Managing the high number of visitors to Regional Parks and providing information about the different natural features and facilities in each park is a challenge. Signs are a highly visible and effective tool in recreation management. This is an obvious way to help meet this challenge.

Advantages to using signs

Signs ...

- Create a sense of arrival (words and supporting structure)
- Provide for information and orientation
- Provide for safety
- Can help define a place
- Can help in managing a site and minimising visitor impact
- Can provide information close to the feature in question
- Help reduce staffing requirements
- Production and maintenance costs are relatively low
- Can be changed, updated or removed as needed
- Can enhance the visitor's experience and appreciation of a place
- Convey a positive image of the management agency when well designed, constructed and sited. This is where planning and standards come into play.

Other communication options

Signs are an effective management tool that aid in maximising the visitor experience and minimising visitor impact. Signs however, create visual impact and require expenditure and resources in their design, production, installation and maintenance. So, it is important to consider the variety of ways in which we can communicate with park visitors before, during and after they visit our parks, and select the most effective communication method. Communication planning is a tool that helps to determine the most effective methods for communicating with visitors, which include print, digital and face-to face methods. The department's Interpretation, Marketing and eMedia Unit provides guidance, support and resources for communication planning.

For communication options in Perth's Regional Parks, please refer to the Regional Parks Communication Strategy (2003) and the Communication Toolkit (PDF) prepared by the Interpretation, Marketing and eMedia Unit to consider the suite of methods available and options you might use with, or instead of, signs.

The Regional Parks Communication Strategy (2003) is a detailed document that was developed to promote the conservation and enjoyment of regional park values. Although some of the specific methods may be outdated, this strategy still provides useful information about park values and outlines a thematic approach to communicating with visitors within individual parks and across the park network.

Appendix B

Sign Planning

When signs are required in a park, then sign planning helps us to decide how and where to use them. The process of sign planning can be used to review and upgrade signs at an existing site, or plan for a completely new site. The following information is a step-by-step guide to developing a sign plan and using it to assist you with sign budgeting, ordering, installation and maintenance.

Do I need a sign plan?

This depends on the complexity of the project (i.e. size and complexity of project area, number of signs, range of sign types required). A sign plan should be prepared for all substantial sign purchasing and installation projects, for example, to install signs throughout the Point Peron area.

1. Site description

Undertake some preliminary desktop research to obtain an overview of the location and an understanding of park features and values. Gather useful maps of the site at different scales - big picture context and detailed site maps. This information will provide you with orientation to the site and context for your sign planning.

Conduct a site visit with Regional Parks staff, the Recreation, Planning and Design Unit staff, an Interpretation Officer and any other project staff to obtain a clear understanding of the site (natural and built features) and site issues, constraints and opportunities.

2. Inventory and evaluation

Existing signs provide additional information about a site use along with risks and issues. Undertake an inventory and evaluation of existing signs (content and position). Record your observations with photos, drawings and notes, then list a recommended action beside each sign (e.g. upgrade, update, replace, move, remove, retain).

3. Needs assessment

Identify visitor types (demographics, activities, site use, access, flow and impacts) to build a picture of your visitor profile and how they use the site. Talk to staff who service and manage the site, to obtain a good understanding about visitor risks and unsustainable activities or behaviours at the site. List all messages that need to be communicated at the site through the use of signs.

4. Sign plan

The sign plan is a document that recommends and describes a collection of signs at a site that are designed to meet the needs of users and park managers. It comprises two parts - a description of the signs (list) and a map showing the location of each sign.

Appendix B

Sign Planning

The sign list should include all of the identified messages being communicated on site through signs and provide details of sign type, structure, reference numbers (as per the Regional Parks manual) content, reason for use and any additional notes. TIP: keep the plan simple and visual and include photos of existing signs and drawings of new signs.

Give each sign a unique code and plot its location on a map or maps at different scales. If there are many signs at a site it can be helpful to distinguish between different types of signs in your plan using colours and/or symbols.

Work with district and project staff to fine tune the sign plan and then have it approved.

Note: If the site is a new development or redevelopment, then contact the Recreation, Planning and Design Unit to obtain a site masterplan that shows details of visitor access (roads, paths) and facilities. Use the site masterplan as the basis for your sign plan.

5. Sign budget

Use the approved sign plan to develop a detailed budget and have that approved.

Note: Decide if the sign manufacturer will be producing and installing the completed signs or manufacturing the signs only (i.e. Regional Parks staff will install the completed signs) as the first option will add costs to the sign budget.

Contact the Interpretation, Marketing and eMedia Unit Coordinator for advice on sign costs and/or quotes.

6. Design and production orders

Convert the sign plan into simple lists or spreadsheets that will assist with design and production orders for the signs and supporting structures.

7. Maintenance and evaluation program


While conducting your annual risk assessment program, you can incorporate a check of all signs at a site. Using the sign plan as a reference, you can record, assess and review the status of signs there; i.e. presence/absence (particularly important for risk signs), condition and effectiveness. Any follow-up tasks can then be included in your annual maintenance works program.

Appendix B


Sign Planning

Sign planning tips

- Signs create visual impact. A well-designed site can reduce the number of signs required. Effective site design and sign planning is the key to achieving more with less.
- Effective site design and sign planning is the result of a collaborative effort between district staff, site managers, landscape architects and interpretation staff.
- Project management is a way of ensuring effective integration of the professional disciplines of landscape architecture, architecture, interpretive communication and graphic design.
- Think message first! For each site or larger area that you are planning for, there will be key locations where visitors need particular messages ... to get their bearings, find their way, stay safe, be suitably prepared for a recreational activity, know how to act in a way that protects park values or in a way that does not impact adversely on other visitors. Put yourself in the visitor's shoes and move through a site from a logical starting point to an end point. When you have decided what the messages are and where they need to be, then choose a suitable sign format from the sign system.
- The department's Interpretation, Marketing and eMedia Unit provides guidance, support and resources for sign planning.

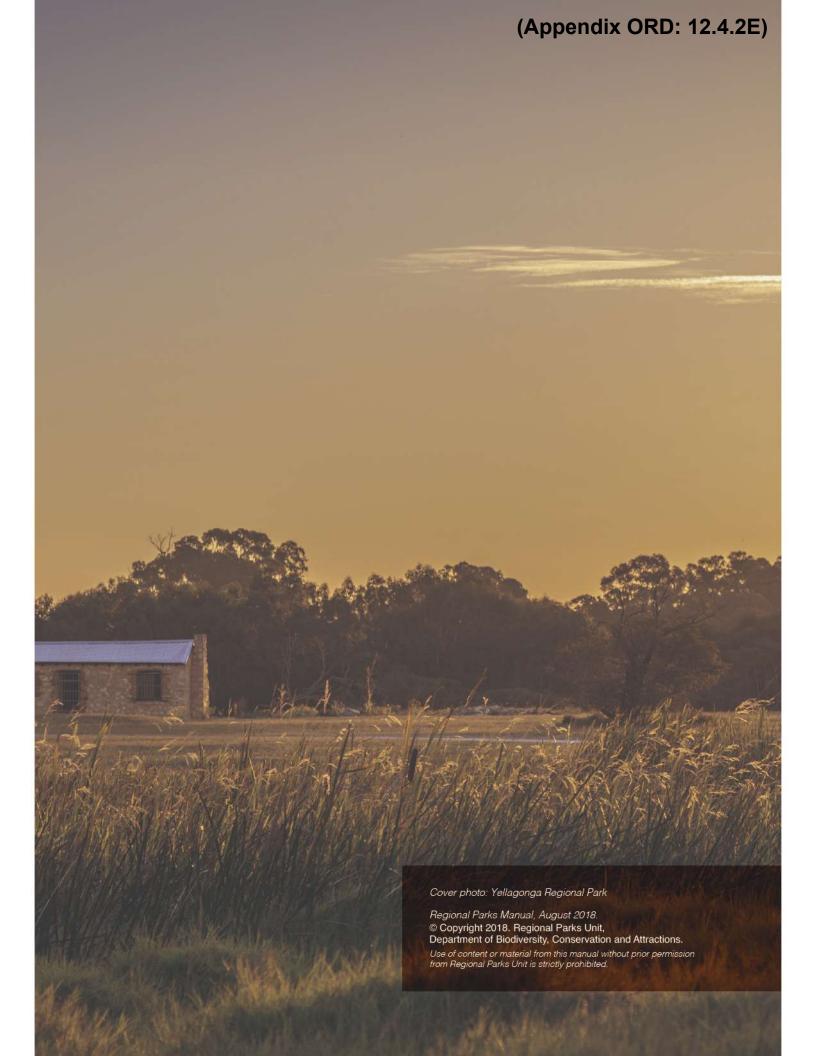



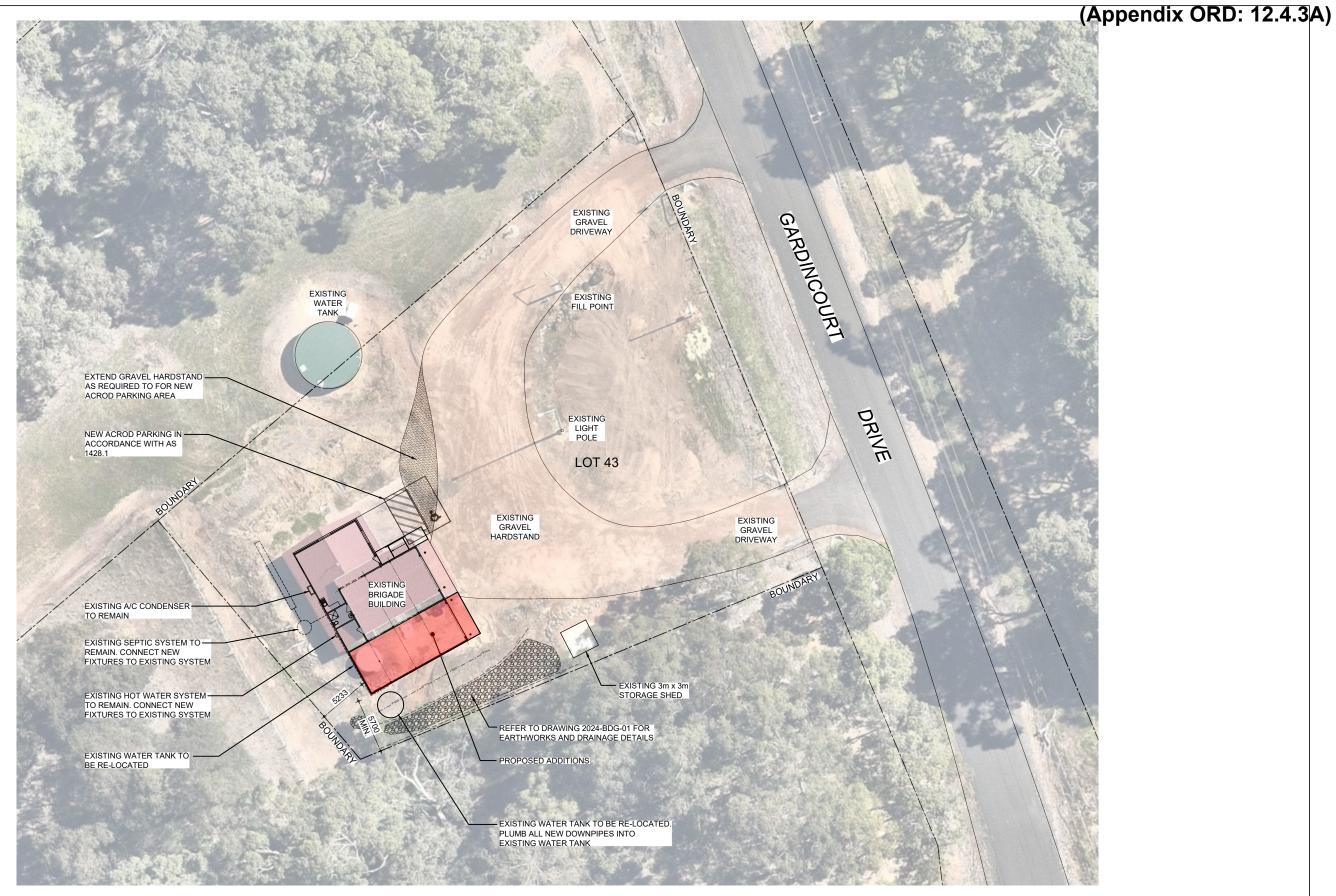

SITE PLAN NOT TO SCALE




١	AMENDMENT DESCRIPTION	BY	DATE	APPROVED	REVIEWED FOR CONSTRUCTION	N AUTHORISED FOR APPROVAL	APPROVED FOR CONSTRUCTION	DRAWING TITLE							
ſ	A ISSUED FOR COMMENT	B.B.	11.03.2025					PROPOSED ADDITIONS TO		INEE	RASTRUCTURE				
Ì					DRAWN	DRAWN DATE	TARDIS RECORD NUMBER	FERGUSON VOLUNTEER BUSH FIRE BRIGADE		IIVI I	VAOTINOOTOINE	-			
Ì					B.B.	06.03.2025		FERGUSUN VOLUNTEER BUSH FIRE BRIGADE					Chiro of	Dar	dani
ł					THIS DRAWING IS AND	SHALL REMAIN THE SOLE	E PROPERTY OF	SITE PLAN			DRAWING NO.		ishire of	Dal (Jidlill
ł					'THE SHIRE OF DARDA	NUP'. THE DRAWING MAY	ONLY BE USED FOR	OTETEN		2025.	-BDG-123-0 ⁻	1			
ŀ						HICH IT WAS COMMISIONE				2020	-000-120-0	•	Administration Centre Eaton P.O Box 7017- 1 Council Drive		08 9724 0000 08 9724 0091
ļ						O OR OTHERWISE DUPLIC	ATED WITHOUT THE		DATUM.	AHD	SHEET NO.		Eaton Western Australia 6232		www.dardanup
١					WRITTEN AUTHORISAT	TION OF THE OWNER.			GRID SYSTEM	f GDA94		SHEET SIZE	ABN: 57 305 829 653		

(Appendix ORD: 12.4.3A) 2 MAX



VOU DIG www.1100.com.au

AMENDMENT DESCRIPTION

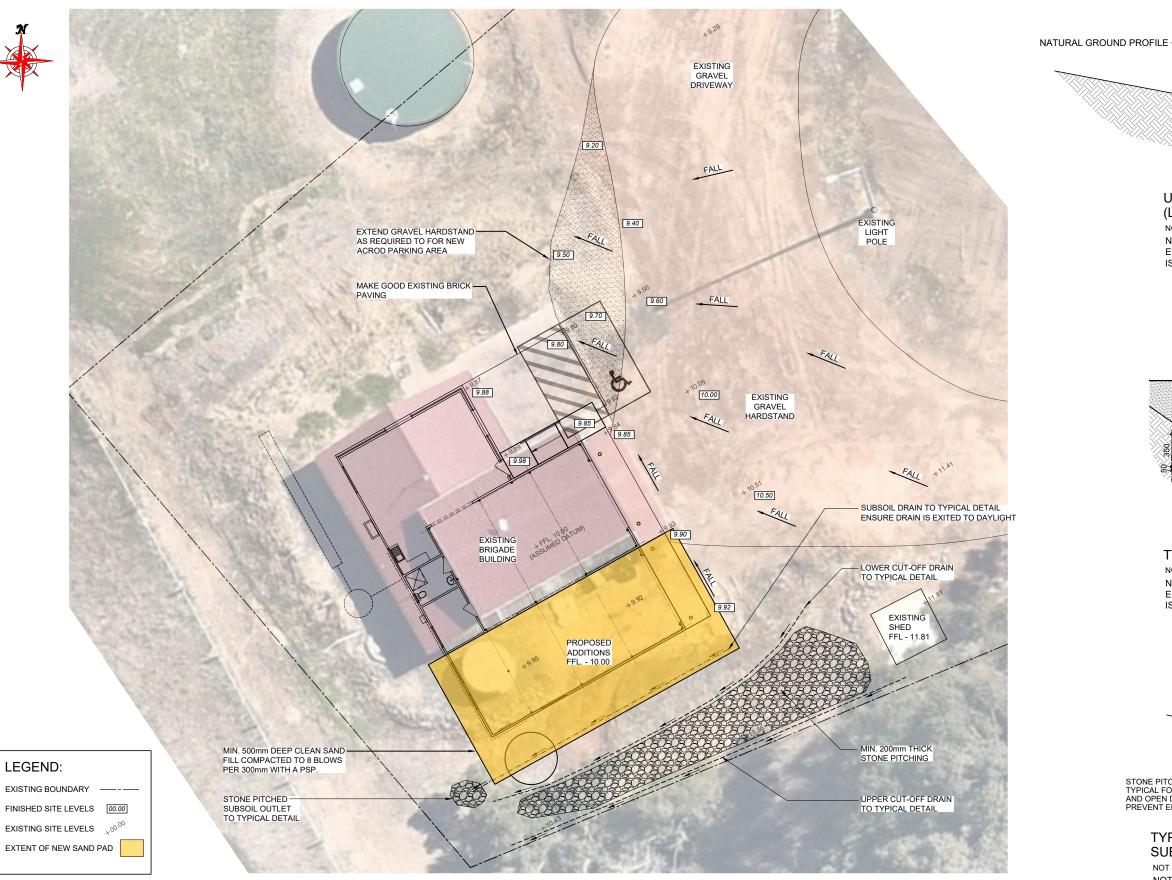


UPPER CUT-OFF DRAIN (LOWER CUT-OFF DRAIN SIMILAR)

NOT TO SCALE

2 MAX

NOTE:


ENSURE WATER FROM CUT-OFF DRAINS IS DIRECTED AWAY FROM ALL BUILDINGS.

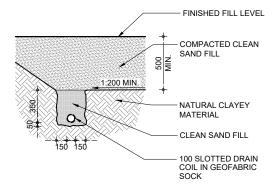

TYPICAL SUBSOIL DRAIN

NOT TO SCALE

ENSURE WATER FROM CUT-OFF DRAINS IS DIRECTED AWAY FROM ALL BUILDINGS.

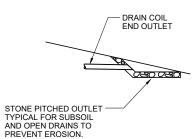

TYPICAL STONE PITCHED SUBSOIL OUTLET

SHEET SIZE

NOT TO SCALE

NOTE:

ENSURE WATER FROM CUT-OFF DRAINS IS DIRECTED AWAY FROM ALL BUILDINGS.

EARTHWORKS AND DRAINAGE PLAN

APPROVED REVIEWED FOR CONSTRUCTION AUTHORISED FOR APPROVAL APPROVED FOR CONSTRUCTION



PROPOSED ADDITIONS TO

EARTHWORKS AND DRAINAGE PLAN

Α	ISSUED FOR COMMENT	B.B.	11.03.2025				
					DRAWN	DRAWN DATE	TARDIS RECORD NUMBER
					B.B.	06.03.2025	
					D.D.	00.03.2025	
						•	
					THIS DRAWING IS AND:	SHALL REMAIN THE SOLE	PROPERTY OF
					ITUE QUIDE OF DADDAA	UIDLEUE DRAWING MAY	ONLY DE LIGED FOR
					THE SHIRE OF DARDAR	IUP'. THE DRAWING MAY (DNLY BE USED FOR
					THE PURPOSE FOR WH	ICH IT WAS COMMISIONE	D. AND MAY NOT BE
					LENT, SHOWN, COPIED	OR OTHERWISE DUPLICA	TED WITHOUT THE
					1 WRITTEN AUTHORISAT	ON OF THE OWNER.	
			I	I			

DATE

INFRASTRUCTURE FERGUSON VOLUNTEER BUSH FIRE BRIGADE

GRID SYSTEM GDA94


2025-BDG-123-02



SHEET NO.

P.O Box 7017- 1 Council Drive Eaton Western Australia 6232 57 305 829 653



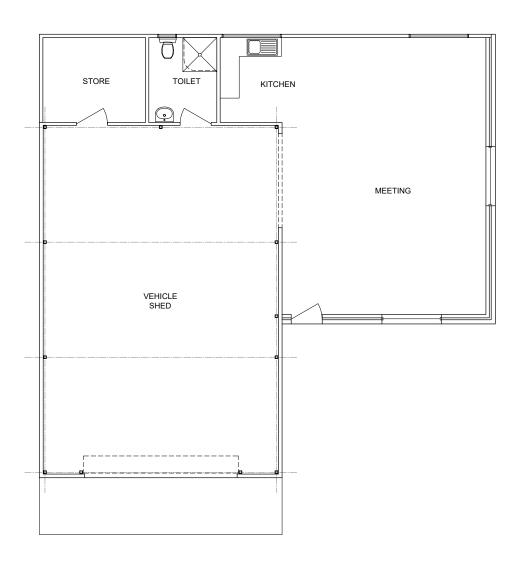


EXISTING FLOOR PLAN


SCALE;		ППППП			
1:100					
at A3 () ′	lm '	2 -	3 4	1 5




	AMENDMENT DESCRIPTION	BY	DATE	APPROVED	REVIEWED FOR CONSTRUCTION AUTHORISED FOR APPROVAL	APPROVED FOR CONSTRUCTION	DRAWING TITLE		
Α	ISSUED FOR COMMENT	B.B.	11.03.2025				PROPOSED ADDITIONS TO	INFRASTRUCTURE	
					DRAWN DATE	TARDIS RECORD NUMBER	FERGUSON VOLUNTEER BUSH FIRE BRIGADE	INTRACTIONE	
					B.B. 06.03.2025		TEROOSON VOLONTEEN BOSITTINE BRIGADE	DDAWING NO	Chira of Dardanun
					THIS DRAWING IS AND SHALL REMAIN THE SOLE		EXISTING FLOOR PLAN	DRAWING NO.	
					'THE SHIRE OF DARDANUP'. THE DRAWING MAY			2025-BDG-123-03	Administration Centre Eaton Telephone 08 9724 0000
					THE PURPOSE FOR WHICH IT WAS COMMISIONE LENT. SHOWN. COPIED OR OTHERWISE DUPLIC	,			P.O Box 7017- 1 Council Drive Facsimile 08 9724 0001
					WRITTEN AUTHORISATION OF THE OWNER.	ALLO WITHOUT THE		DATUM. AHD SHEET NO. SHEET SIZE	Eaton Western Australia 6232 Online www.dardanup.wa.gov.au

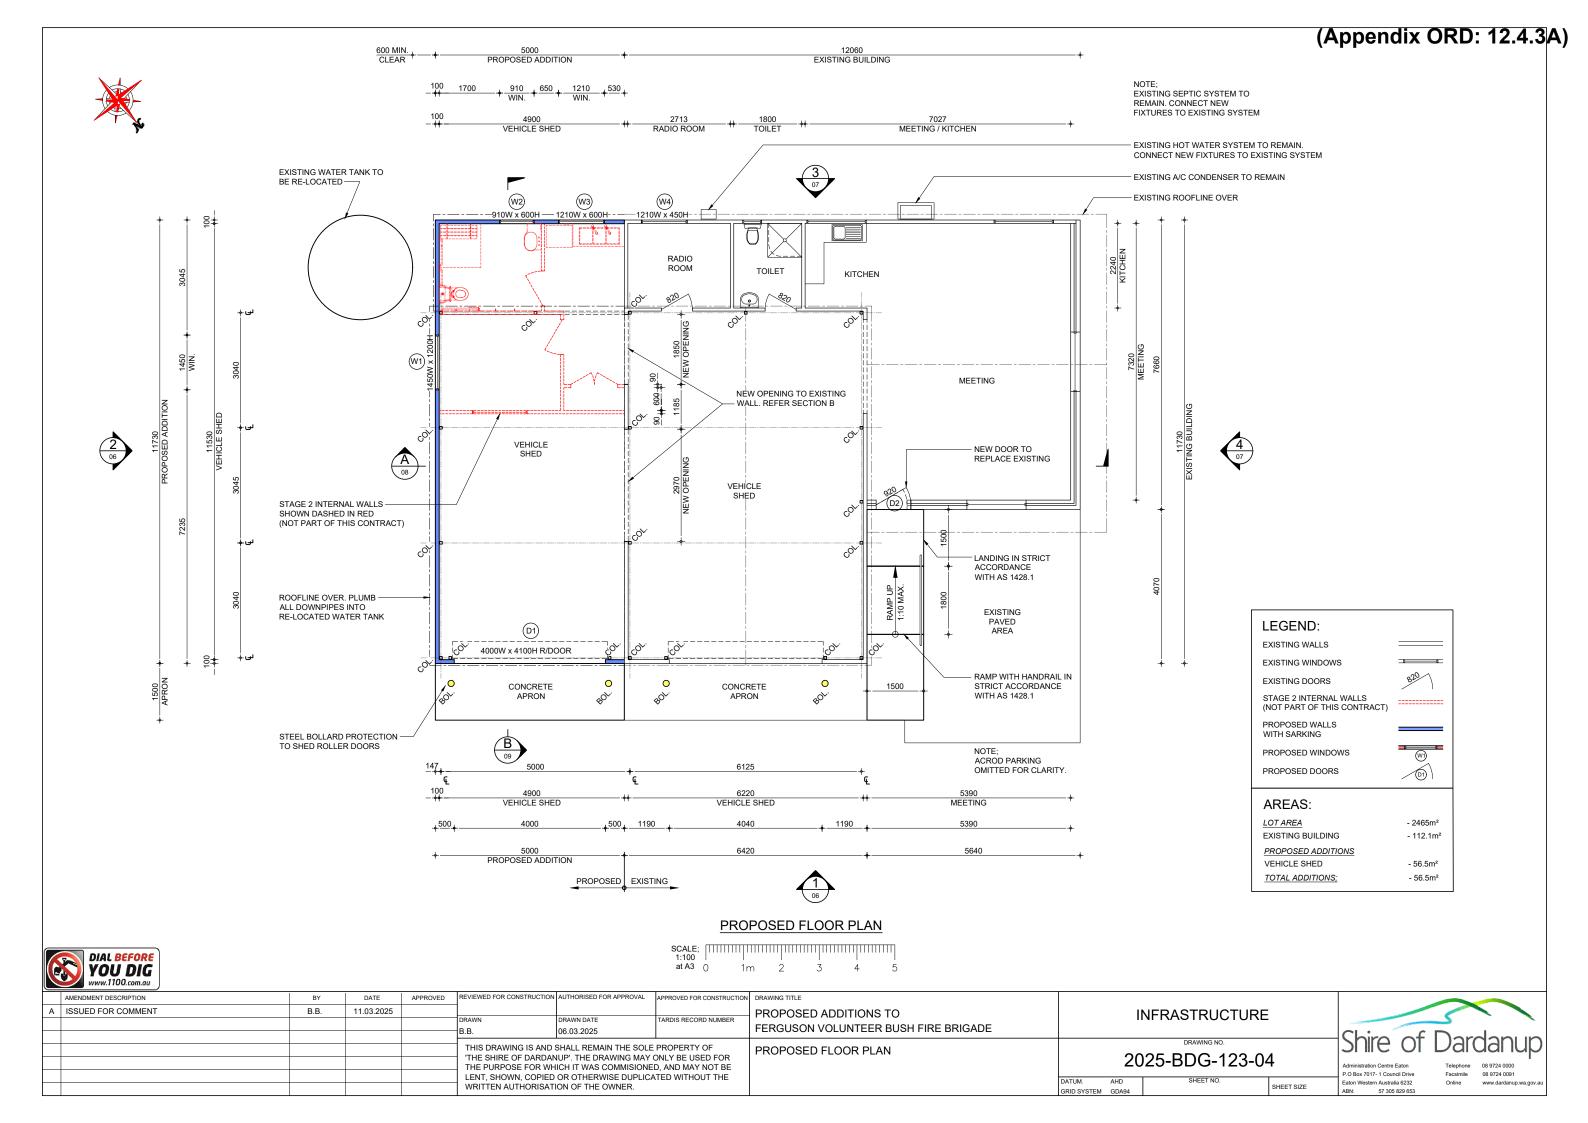



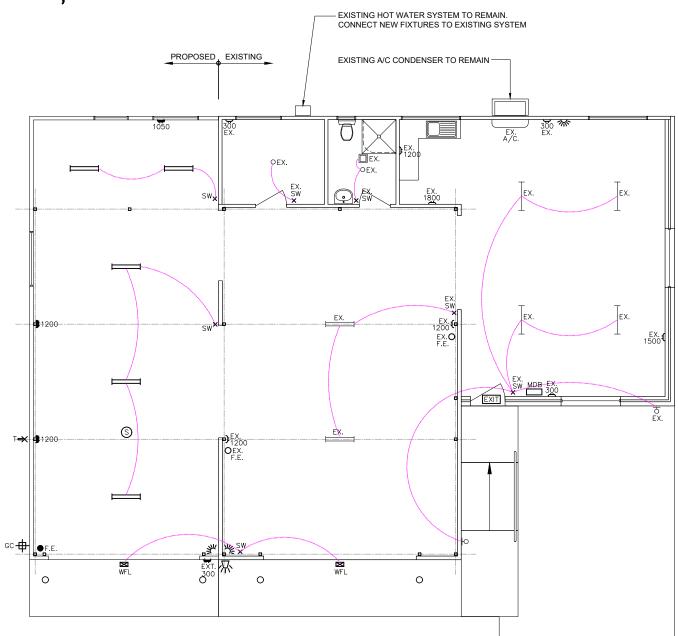

ELECTRICAL AND FIRE PLAN

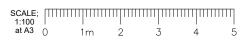

ELECTRICAL & FIRE LEGEND:


- O EX. EXISTING CEILING MOUNTED BAYONET FITTING
- ਰ ex. EXISTING WALL OR CEILING MOUNTED EXTERNAL LIGHT FIGHTING
- EX. EXISTING 2x38W FLUORESCENT FITTING SURFACE MOUNTED (TO DOUBLE AS EMERGENCY LIGHTING)
- EX. EXISTING 1x38W FLUORESCENT FITTING CEILING MOUNTED (TO DOUBLE AS EMERGENCY LIGHTING)
 - MAX. 36W SURFACE MOUNTED LUMINAIRE LED 1200 LONG (TO DOUBLE AS EMERGENCY LIGHTING)
- MDB EXISTING MAIN DISTRIBUTION BOARD
- 300 EXISTING POWER POINT / HEIGHT ABOVE FFL
- \$300 15amp DOUBLE GPO / HEIGHT ABOVE FFL
- FEXT. 15amp EXTERNAL WATERPROOF DOUBLE GPO / HEIGHT ABOVE FFL
- CONNECTION POINT FOR FUTURE BACK-UP GENERATOR
- EXTERNAL WALL MOUNTED LED FLOOD

 LIGHTING WITH VANDAL PROOF LIGHT
 FITTINGS CONTROLLED BY TIME
 CLOCK AND LIGHT SENSORS
- WALL MOUNTED MOTION DETECTION SECURITY SENSOR WITH CAMERA
- WALL MOUNTED SECURITY ALARM SIREN
- × SW EXISTING LIGHT SWITCH
- × SW LIGHT SWITCH 1050 AFL (UNO)
- x MSW MASTER LIGHT SWITCH PANEL
 3D2 2 PLUG DATA/TELSTRA OUTLET
- POINT IN SKIRTING DUCT
- EXISTING CEILING MOUNTED FAN WITH MECHANICAL EXTRACTION FLUMED TO OUTSIDE AIR
- CEILING MOUNTED FAN WITH
 SELF CLOSING DAMPERS FOR
 MECHANICAL EXTRACTION OF
 AMENITIES
- O_{F,F} EXISTING FIRE EXTINGUISHER
- F.E. FIRE EXTINGUISHER
- FHR 36.0m FIRE HOSE REEL
- ₩ WALL MOUNTED TAP
- S SMOKE ALARM HARD WIRED AND INTERCONNECTED
- **EXIT** EMERGENCY EXIT SIGN
- ELECTRICAL WIRING TO AS/NZS 3000


NOTE:

ALL EXTERNAL FLOOD LIGHTS TO BE CONNECTED TO MASTER LIGHT SWITCH PANEL LOCATED IN THE VEHICLE SHED.

INSTALL TV ANTENNA AND COMMUNICATIONS ANTENNA'S FOR OPERATIONAL EQUIPMENT TO THE SATISFACTION OF THE SHIRE OF DARDANUP.

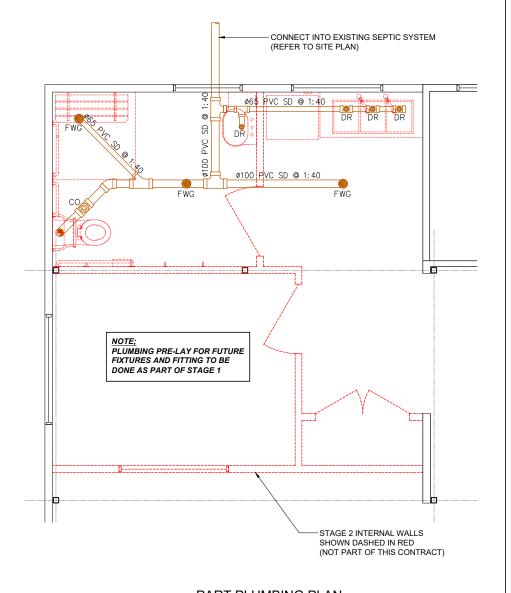

PART PLUMBING PLAN

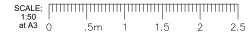

PLUMBING LEGEND:

FWG - FLOOR WASTE GULLY


CO CO - CLEAN OUT POINT


DR - SINK DRAIN

SD - SANITARY DRAINAGE PIPE



	AMENDMEN ³	NT DESCRIPTION	BY	DATE	APPROVED	REVIEWED FOR CONSTRUCTION	IN AUTHORISED FOR APPROVAL	APPROVED FOR CONSTRUCTION	DRAWING TITLE							
Α	ISSUED F	FOR COMMENT	B.B.	11.03.2025					PROPOSED ADDITIONS TO			INFRASTRUCTURE				
						DRAWN	DRAWN DATE	TARDIS RECORD NUMBER				INITIAOTIAOCIONE	•			
-	_					B.B.	06.03.2025		FERGUSON VOLUNTEER BUSH FIRE BRIGADE					CI ·		
										 		DRAWING NO.		ishire of I	1)ard	lanı in l
							D SHALL REMAIN THE SOLE		ELECTRICAL AND FIRE PLAN		_		_		Dala	iai iap i
							ANUP'. THE DRAWING MAY		AND DADT DILIMBING DI ANI		2	025-BDG-123-0	5	Administration Centre Faton	T-1 0(00.0704.0000
-	_						HICH IT WAS COMMISIONE	,	AND PART PLUMBING PLAN		_	0_0 0 0		P.O Box 7017- 1 Council Drive	Telephone 08 Facsimile 08	08 9724 0000
							D OR OTHERWISE DUPLICA	TED WITHOUT THE		DATUM.	AHD	SHEET NO.		Faton Western Australia 6232		www.dardanup.wa.gov.au
						WRITTEN AUTHORISA	ITION OF THE OWNER.			CDID EVETE	M CDAM		SHEET SIZE	ARN: 57 305 820 653		

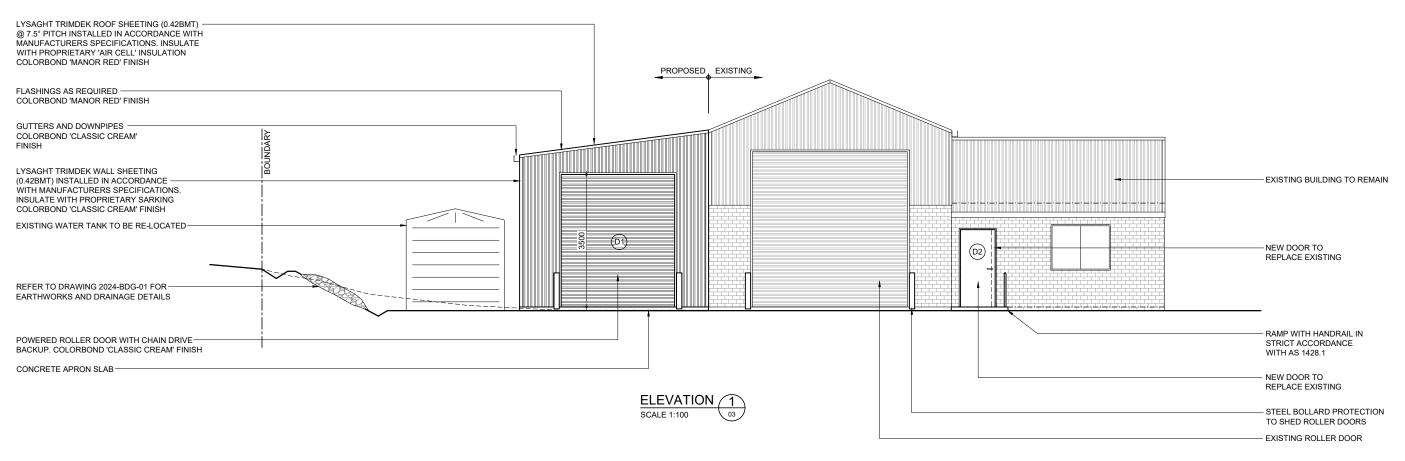

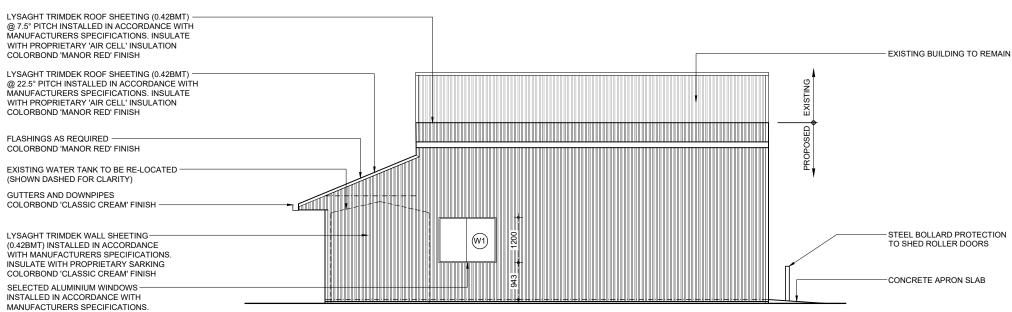







COLORBOND 'CLASSIC CREAM' FINISH

	AMENDMENT DESCRIPTION	BY	DATE	APPROVED	REVIEWED FOR CONSTRUCTION AUTHORISED FOR APPROVAL	APPROVED FOR CONSTRUCTION	DRAWING TITLE						17.0	
Α	A ISSUED FOR COMMENT	B.B.	11.03.2025				PROPOSED ADDITIONS TO		1	INFRASTRUCTUR	=			
					DRAWN DATE	TARDIS RECORD NUMBER					_			
\vdash			+		B.B. 06.03.2025		FERGUSON VOLUNTEER BUSH FIRE BRIGADE					Claire C		.1
\vdash					THE PRAMENOUS AND SHALL BEMAIN THE SOLE	DDODEDTY OF				DRAWING NO.		ishire ot	Dar	MANI IN
					THIS DRAWING IS AND SHALL REMAIN THE SOLE		ELEVATIONS		00	00E DDQ 400 0			Dar	adı idp
					THE SHIRE OF DARDANUP'. THE DRAWING MAY C THE PURPOSE FOR WHICH IT WAS COMMISIONED		SHEET 1		20	025-BDG-123-0	6	Administration Centre Faton	Telephone	08 9724 0000
					LENT. SHOWN, COPIED OR OTHERWISE DUPLICA		SHEET					P.O Box 7017- 1 Council Drive		08 9724 0091
					WRITTEN AUTHORISATION OF THE OWNER.	KIED WITHOUT THE		DATUM.	AHD	SHEET NO.	SHEET SIZE	Eaton Western Australia 6232	Online	www.dardanup.wa.gov.a
					WRITTEN AUTHORISATION OF THE OWNER.			GRID SYSTEM	GDA94		SHEET SIZE	ABN: 57 305 829 653		

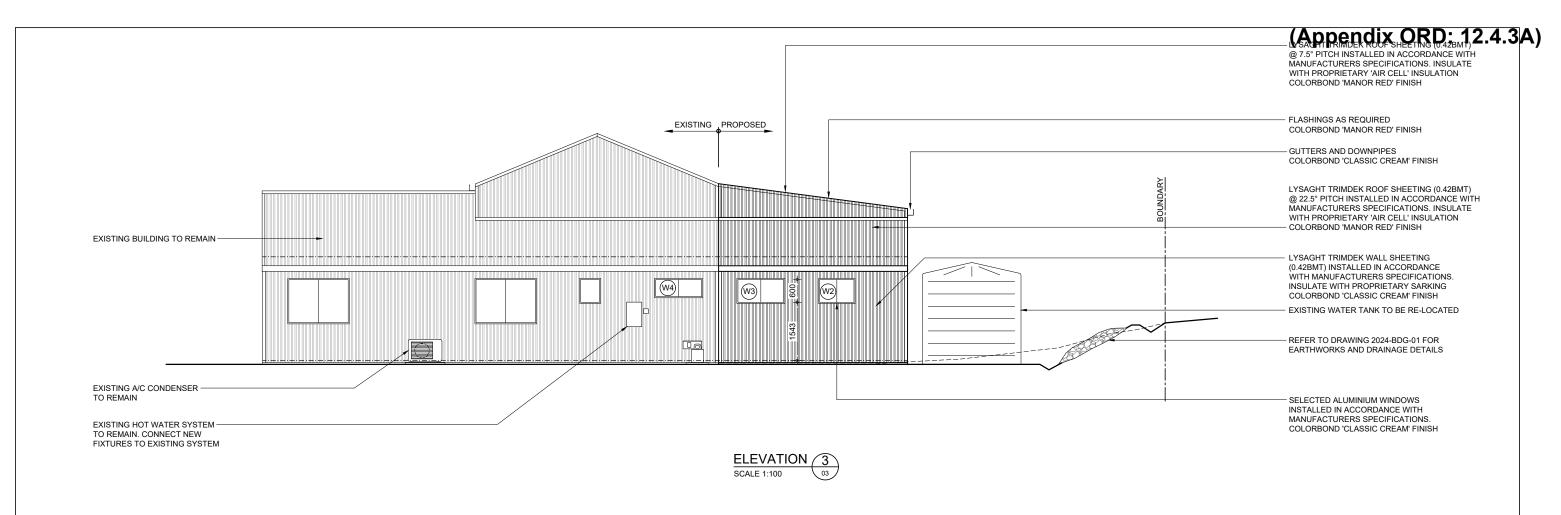


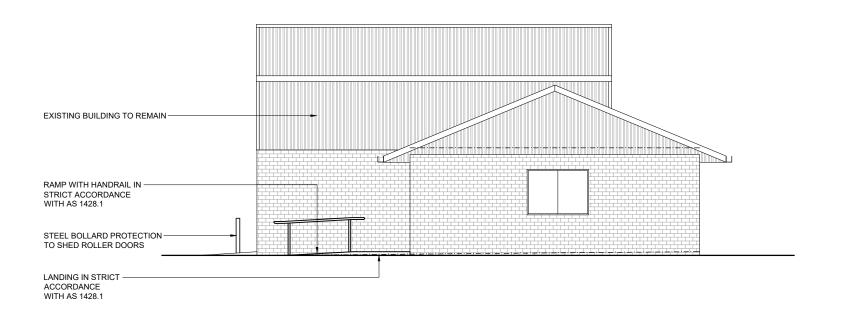

ELEVATION 4 SCALE 1:100 03



AMENDMENT DESCRIPTION	BY	DATE	API	PPROVED	REVIEWED FOR CONSTRUCTION	AUTHORISED FOR APPROVAL	APPROVED FOR CONSTRUCTION	DRAWING TITLE							
A ISSUED FOR COMMENT	B.B.	11.03.202	25					PROPOSED ADDITIONS TO		1	NFRASTRUCTUR	_			
					DRAWN	DRAWN DATE	TARDIS RECORD NUMBER			ı	INI INASTINUCTUR	L			
			_		B.B.	06.03.2025		FERGUSON VOLUNTEER BUSH FIRE BRIGADE					CI · C		
					T. 110 D.D. 114 114 10 10 114 11	011411 DEMANUTUE 0015	- DDODEDTI / OF				DRAWING NO.		-Shire of	I)ard:	anup
						SHALL REMAIN THE SOLE		ELEVATIONS		0.0	NOT DDO 400 (\ 7		Dala	
						HIRE OF DARDANUP'. THE DRAWING MAY ONLY BE USED IRPOSE FOR WHICH IT WAS COMMISIONED, AND MAY NO SHOWN, COPIED OR OTHERWISE DUPLICATED WITHOUT EN AUTHORISATION OF THE OWNER.				2025-BDG-123-07			Administration Centre Eaton	Telephone 08	3 9724 0000
													P.O Box 7017- 1 Council Drive		3 9724 0091
							ATED WITHOUT THE		DATUM.	AHD	SHEET NO.	SHEET SIZE	Eaton Western Australia 6232	Online ww	ww.dardanup.wa.gov.au
					WINITENAUTHORISAT	ION OF THE OWNER.			GRID SYST	TEM GDA94		OTTLL I SIZE	ABN: 57 305 829 653		

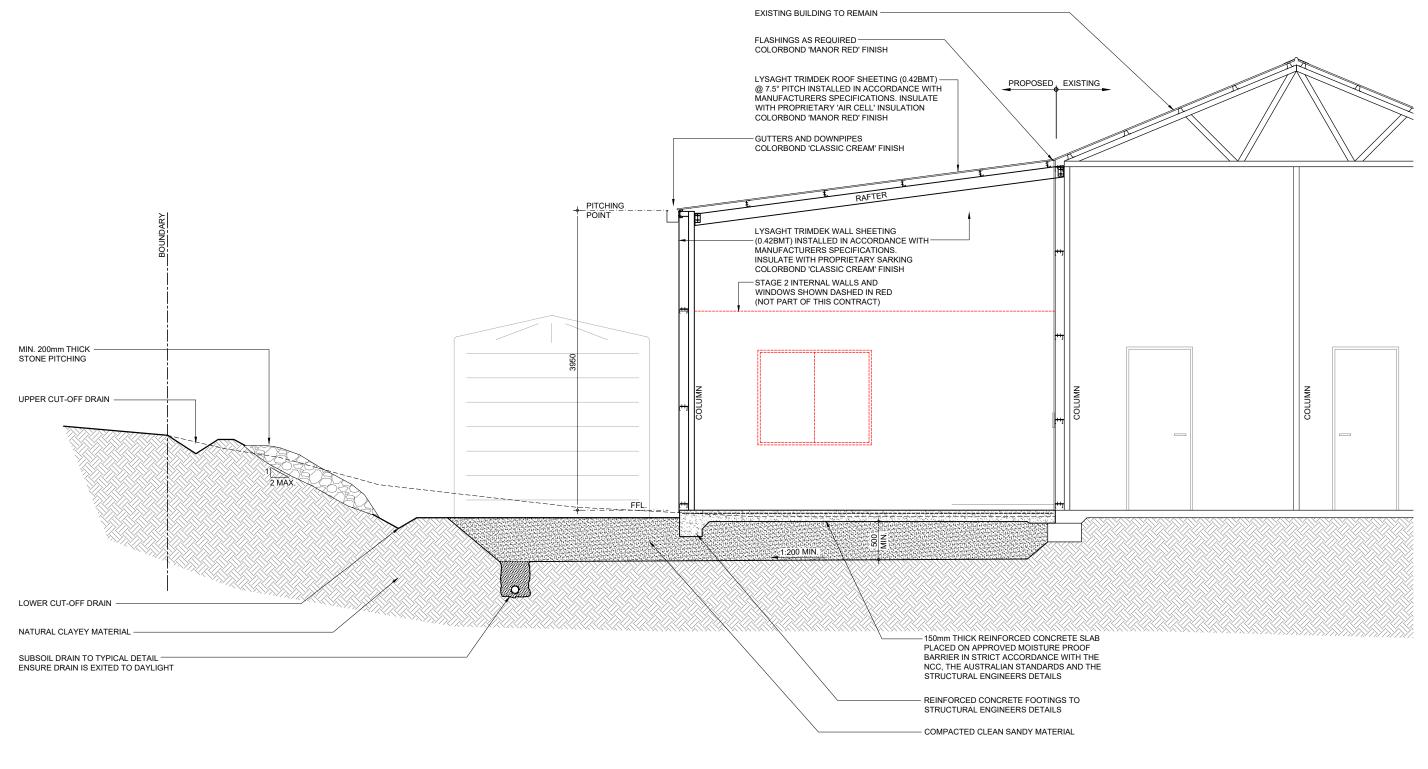

SECTION A
SCALE 1:50 03



	AMENDMENT DESCRIPTION	BY	DATE	APPROVED	REVIEWED FOR CONSTRUCTION	AUTHORISED FOR APPROVAL	APPROVED FOR CONSTRUCTION	DRAWING TITLE					
Α	A ISSUED FOR COMMENT	B.B.	11.03.2025					PROPOSED ADDITIONS TO	l In	NFRASTRUCTURE	=		
					DRAWN	DRAWN DATE	TARDIS RECORD NUMBER		"	NI INASTINUCTURI	_		
-					B.B.	06.03.2025		FERGUSON VOLUNTEER BUSH FIRE BRIGADE				CI ·	
						L				DRAWING NO.		15hire of	L)ardanun
						SHALL REMAIN THE SOLE		SECTION A					Dalual lup
						NUP'. THE DRAWING MAY			1 20	25-BDG-123-0	18		'
					THE PURPOSE FOR WE	HICH IT WAS COMMISIONE	ED, AND MAY NOT BE		20	20 000 120 0	,0	Administration Centre Eaton	Telephone 08 9724 0000
					LENT, SHOWN, COPIED	OR OTHERWISE DUPLICATION	ATED WITHOUT THE		DATUM AHD	SHEET NO.		P.O Box 7017- 1 Council Drive Faton Western Australia 6232	Facsimile 08 9724 0091
					WRITTEN AUTHORISAT	TON OF THE OWNER.			GRID SYSTEM GDAM		SHEET SIZE	ABN: 57 305 829 653	Online www.dardanup.wa.gov.au

(Appendix ORD: 12.4.3A) - FXISTING BUILDING TO REMAIN LYSAGHT TRIMDEK ROOF SHEETING (0.42BMT) @ 7.5° PITCH INSTALLED IN ACCORDANCE WITH MANUFACTURERS SPECIFICATIONS. INSULATE FLASHINGS AS REQUIRED -WITH PROPRIETARY 'AIR CELL' INSULATION COLORBOND 'MANOR RED' FINISH COLORBOND 'MANOR RED' FINISH LYSAGHT TRIMDEK ROOF SHEETING (0.42BMT) — @ 22.5° PITCH INSTALLED IN ACCORDANCE WITH MANUFACTURERS SPECIFICATIONS. INSULATE WITH PROPRIETARY 'AIR CELL' INSULATION COLORBOND 'MANOR RED' FINISH RAFTER RAFTER RAFTER RAFTER - LYSAGHT TRIMDEK WALL SHEETING (0.42BMT) INSTALLED IN ACCORDANCE WITH PROPRIETARY ENGINEERED STEEL ROOF TRUSSES DOOR HEAD MANUFACTURERS SPECIFICATIONS. INSULATE WITH PROPRIETARY SARKING COLORBOND 'CLASSIC CREAM' FINISH GUTTERS AND DOWNPIPES-COLORBOND 'CLASSIC CREAM' FINISH EXISTING CROSS BRACING TO BE POWERED ROLLER DOOR WITH CHAIN MODIFIED TO SUIT NEW OPENING REFER TO STRUCTURAL ENGINEER COLORBOND 'CLASSIC CREAM' FINISH PITCHING DOOR HEAD POINT FIBRE CEMENT SHEETING ON FURRING -150mm THICK REINFORCED CONCRETE SLAB CHANNELS TO ALL EAVES. PAINT FINISH 700 PLACED ON APPROVED MOISTURE PROOF BARRIER IN STRICT ACCORDANCE WITH THE SELECTED ALUMINIUM WINDOWS NCC, THE AUSTRALIAN STANDARDS AND THE INSTALLED IN ACCORDANCE WITH STRUCTURAL ENGINEERS DETAILS MANUFACTURERS SPECIFICATIONS COLORBOND 'CLASSIC CREAM' FINISH - ENSURE MIN. 20mm REBATE TO SLAB EDGE TO ENSURE WATERPROOFING PROPRIETARY ENGINEERED STEEL WALL FRAMING STEEL BOLLARD PROTECTION LYSAGHT TRIMDEK WALL SHEETING — (0.42BMT) INSTALLED IN ACCORDANCE TO SHED ROLLER DOORS CONCRETE APRON SLAB INSULATE WITH PROPRIETARY SARKING COLORBOND 'CLASSIC CREAM' FINISH 100mm THICK REINFORCED CONCRETE SLAB-PLACED ON APPROVED MOISTURE PROOF BARRIER IN STRICT ACCORDANCE WITH THE NCC. THE AUSTRALIAN STANDARDS AND THE STRUCTURAL ENGINEERS DETAILS REINFORCED CONCRETE FOOTINGS TO STRUCTURAL ENGINEERS DETAILS COMPACTED CLEAN SANDY MATERIAL SECTION B NATURAL CLAYEY MATERIAL-SCALE 1:50 03 DIAL BEFORE **YOU DIG** www.1100.com.au REVIEWED FOR CONSTRUCTION AUTHORISED FOR APPROVAL AMENDMENT DESCRIPTION BY DATE APPROVED PPROVED FOR CONSTRUCTION DRAWING TITLE A ISSUED FOR COMMENT B.B. 11.03.2025 INFRASTRUCTURE PROPOSED ADDITIONS TO ARDIS RECORD NUMBER FERGUSON VOLUNTEER BUSH FIRE BRIGADE 06.03.2025 THIS DRAWING IS AND SHALL REMAIN THE SOLE PROPERTY OF SECTION B 'THE SHIRE OF DARDANUP'. THE DRAWING MAY ONLY BE USED FOR 2025-BDG-123-09 THE PURPOSE FOR WHICH IT WAS COMMISIONED, AND MAY NOT BE LENT, SHOWN, COPIED OR OTHERWISE DUPLICATED WITHOUT THE WRITTEN AUTHORISATION OF THE OWNER. SHEET NO aton Western Australia 6232 SHEET SIZE GRID SYSTEM GDA94 57 305 829 653

DOOR NUMBER	TOTAL	DOOR TYPE	PANEL TYPE	PANEL FINISH	FRAME TYPE	FRAME FINISH	HEIGHT	WIDTH	ADDITIONAL INFORMATION / COMMENTS
D1	1	AUTOMATIC ROLLER DOOR	MANUFACTURERS	POWDERCOATED COLORBOND - 'CLASSIC CREAM'	GALVANISED STEEL	PROPRIETARY TO MANUFACTURERS SPECIFICATIONS	3500mm	AS REQUIRED FOR 4000mm OPENING	INSTALL IN STRICT ACCORDANCE WITH THE MANUFACTURERS SPECIFICATIONS. PROVIDE BACK-UP MANUAL CHAIN DRIVE FOR OPERATING DOORS MANUALLY. ENSURE MIN. 20mm REBATE TO SLAB EDGE TO ENSURE WATERPROOFING.
D5	1	EXTERNAL SWING DOOR	ZINCALUME SHEET	POWDERCOATED COLORBOND - 'CLASSIC CREAM'	GALVANISED STEEL	PAINT FINISH COLOUR TO MATCH EXISTING	2040mm	920mm	INSTALL DOOR BUFFERS AND STOPS, EXTERNAL STRIKER PLATES TO DOOR LATCHES TO BE STEEL NOSED WITH WEATHER BAR AND SEAL. BOLT LATCHES TO BE FITTED TOP AND BOTTOM INTERNALLY.
WINDOW SC	CHEDUL	E:							
WINDOW NUMBER	R TOTA	L WINDOW TYPE	FRAME TYPE	FRAME FINISH	GLAZING	HEAD	SILL	ADDITIONAL IN	FORMATION / COMMENTS
W1	1	1450W x 1200H SLIDING WINDOW	PROPRIETARY ALUMINIUM FRAME	POWDERCOATED COLORBOND - 'CLASSIC CREAM'	CLEAR SINGLE GLAZING	2143mm AFL	1586mm AFL	MIN. VERTICAL C	WINDOW BAR SECURITY SCREENS FIXED TO FACE OF BUILDING STRUCTURE. CTS. OF BARS 100mm - MAX. 150mm. FRAMES TO BE ADEQUATELY TREATED FOR COSION RESISTANCE. COLORBOND 'BUSHLAND' FINISH.
W2	1	910W x 600H SLIDING WINDOW	PROPRIETARY ALUMINIUM FRAME:	POWDERCOATED COLORBOND - 'CLASSIC CREAM'	OPAQUE SINGLE GLAZING	2443mm AFL	1586mm AFL	MIN. VERTICAL C	WINDOW BAR SECURITY SCREENS FIXED TO FACE OF BUILDING STRUCTURE. CTS. OF BARS 100mm - MAX. 150mm. FRAMES TO BE ADEQUATELY TREATED FOR COSION RESISTANCE. COLORBOND 'BUSHLAND' FINISH.
W3	1	1210W x 600H SLIDING WINDOW	PROPRIETARY ALUMINIUM FRAME:	POWDERCOATED COLORBOND - 'CLASSIC CREAM'	OPAQUE SINGLE GLAZING	2143mm AFL	1586mm AFL	MIN. VERTICAL C	WINDOW BAR SECURITY SCREENS FIXED TO FACE OF BUILDING STRUCTURE. CTS. OF BARS 100mm - MAX. 150mm. FRAMES TO BE ADEQUATELY TREATED FOR COSION RESISTANCE. COLORBOND 'BUSHLAND' FINISH.
W4	1	1210W x 450H SLIDING WINDOW	PROPRIETARY ALUMINIUM FRAME	POWDERCOATED S COLORBOND - 'CLASSIC CREAM'	OPAQUE SINGLE GLAZING	2143mm AFL	1693mm AFL	MIN. VERTICAL C	MINDOW BAR SECURITY SCREENS FIXED TO FACE OF BUILDING STRUCTURE. CTS. OF BARS 100mm - MAX. 150mm. FRAMES TO BE ADEQUATELY TREATED FOR OSION RESISTANCE. COLORBOND 'BUSHLAND' FINISH.

DOOR NOTES:

- 1) CONTRACTOR TO SUPPLY AND INSTALL KEY LOCK MECHANISMS TO ALL EXTERNAL DOORS AND AS NOTED IN THE SCHEDULE.
 2) CONTRACTOR TO SUPPLY AND INSTALL LOCKING MECHANISMS TO ALL BATHROOM AND TOILET DOORS. FITMENTS TO UAT TO BE IN STRICT ACCORDANCE WITH AS 1428.1.
 3) CONTRACTOR TO SUPPLY AND INSTALL LIFT OFF HINGES TO ALL BATHROOM AND TOILET DOORS IN STRICT ACCORDANCE WITH THE BCA.

- 4) CONTRACTOR TO SUPPLY AND INSTALL ALL NECESSARY DOOR HARDWARE.
 5) REFER TO FLOOR PLAN FOR DOOR ORIENTATION.

WINDOW NOTES:

- 1) CONTRACTOR TO SUPPLY AND INSTALL KEY LOCK MECHANISMS TO ALL EXTERNAL WINDOWS.
 2) CONTRACTOR TO SUPPLY AND INSTALL ALL NECESSARY WINDOW HARDWARE.
 3) CONTRACTOR TO SUPPLY AND INSTALL WINDOW BAR SECURITY SCREENS.
 4) REFER TO ELEVATIONS FOR WINDOW SLIDING DIRECTION.

		VOU DIG www.1100.com.au
	AMENE	MENT DESCRIPTION

AMENDMENT DESCRIPTION	BY	DATE	APPROVED	REVIEWED FOR CONSTRUCTION AUTHORISED FOR APPROVAL	APPROVED FOR CONSTRUCTION	DRAWING TITLE						
ISSUED FOR COMMENT	B.B.	11.03.2025				PROPOSED ADDITIONS TO		ı	NERASTRUCTURE	=		
					TARDIS RECORD NUMBER				IN INACINOCIONE	_		
				B.B. 06.03.2025		FERGUSON VOLUNTEER BUSH FIRE BRIGADE					Chira af [Dardam un
				THIS DRAWING IS AND SHALL REMAIN THE SOLE	PROPERTY OF	DOOD AND WINDOW COLLEDING			DRAWING NO.		ISING OLI	Jardanud
						DOOR AND WINDOW SCHEDULE		20	124 PDC 109 1	Λ		2 ai aai iap
								20	724-DDG-100-1	U	Administration Centre Eaton	Telephone 08 9724 0000
				LENT, SHOWN, COPIED OR OTHERWISE DUPLICA	ATED WITHOUT THE		DATUM	ALID	I SHEET NO			Facsimile 08 9724 0091
				WRITTEN AUTHORISATION OF THE OWNER.			DATOW.		GHEET NO.	SHEET SIZE		Online www.dardanup.wa.gov.au
ŀ		AWENDWENT BESCRIPTION BT		Amendment begond non	ISSUED FOR COMMENT B.B. 11.03.2025 DRAWN DRAWN DATE B.B. 06.03.2025 THIS DRAWING IS AND SHALL REMAIN THE SOLE THE SHIRE OF DARDANUP. THE DRAWING MAY THE PURPOSE FOR WHICH IT WAS COMMISIONE LENT, SHOWN, COPIED OR OTHERWISE DUPLIC.	ISSUED FOR COMMENT B.B. 11.03.2025 DRAWN DRAWN DATE TARDIS RECORD NUMBER B.B. 06.03.2025 THIS DRAWING IS AND SHALL REMAIN THE SOLE PROPERTY OF THE SHIRE OF DARDANUP. THE DRAWING MAY ONLY BE USED FOR THE PURPOSE FOR WHICH IT WAS COMMISIONED, AND MAY NOT BE LENT, SHOWN, COPIED OR OTHERWISE DUPLICATED WITHOUT THE	ISSUED FOR COMMENT B.B. 11.03.2025 DRAWN B.B. 06.03.2025 THIS DRAWING IS AND SHALL REMAIN THE SOLE PROPERTY OF THE SHIRE OF DARDANUP. THE DRAWING MAY ONLY BE USED FOR THE PURPOSE FOR WHICH IT WAS COMMISSIONED, AND MAY NOT BE LENT, SHOWN, COPIED OR OTHERWISE DUPLICATED WITHOUT THE DRAWN FERGUSON VOLUNTEER BUSH FIRE BRIGADE PROPOSED ADDITIONS TO FERGUSON VOLUNTEER BUSH FIRE BRIGADE DOOR AND WINDOW SCHEDULE	ISSUED FOR COMMENT B.B. 11.03.2025 DRAWN DATE OF 06.03.2025 DRAWN B.B. 06.03.2025 THIS DRAWING IS AND SHALL REMAIN THE SOLE PROPERTY OF THE SHIRE OF DARDANUP'. THE DRAWING MAY ONLY BE USED FOR THE PURPOSE FOR WHICH IT WAS COMMISIONED, AND MAY NOT BE LENT, SHOWN, COPIED OR OTHERWISE DUPLICATED WITHOUT THE WRITTEN ALTHORISETION OF THE OWNERD	ISSUED FOR COMMENT B.B. 11.03.2025 DRAWN B.B. 06.03.2025 THIS DRAWING IS AND SHALL REMAIN THE SOLE PROPERTY OF THE SHIRE OF DARDANUP. THE DRAWING MAY ONLY BE USED FOR THE PURPOSE FOR WHICH IT WAS COMMISSIONED, AND MAY NOT BE LENT, SHOWN, COPIED OR OTHERWISE DUPLICATED WITHOUT THE PROPOSED ADDITIONS TO FERGUSON VOLUNTEER BUSH FIRE BRIGADE 20 DOOR AND WINDOW SCHEDULE 21 DATIM AND	ISSUED FOR COMMENT B.B. 11.03.2025 DRAWN DATE OF DAT	ISSUED FOR COMMENT B.B. 11.03.2025 DRAWN DATE OF DAT	ISSUED FOR COMMENT B.B. 11.03.2025 DRAWN DATE OF 06.03.2025 DRAWN DATE OF 06.03.2025 THIS DRAWING IS AND SHALL REMAIN THE SOLE PROPERTY OF THE SHIRE OF DARDANUP. THE DRAWING MAY ONLY BE USED FOR THE PURPOSE FOR WHICH IT WAS COMMISIONED, AND MAY NOT BE LEINT, SHOWN, COPIED OR OTHERWISE DUPLICATED WITHOUT THE WINDIGSTRON OF THE OWNER O

GENERAL NOTES:

VERTICAL DATUM: AUSTRALIAN HEIGHT DATUM (AHD) HORIZONTAL DATUM: GDA94 / MGA zone 50

1. DO NOT SCALE FROM THE DRAWINGS. ALL DIMENSIONS ARE TO THE FACE OF FRAMING OR STRUCTURE. ANY DISCREPANCIES ARE TO BE REFERRED TO THE PROJECT SUPERVISOR FOR A DECISION PRIOR TO COMMENCEMENT OF ANY WORK.

2. THESE DRAWINGS ARE TO BE READ IN CONJUNCTION WITH ALL OTHER CONSULTANTS DRAWINGS AND SPECIFICATIONS.

3. WORKMANSHIP AND MATERIALS ARE TO BE IN ACCORDANCE WITH THE RELEVANT S.A.A. CODES AND THE LOCAL STATUTORY AUTHORITIES REGULATIONS INCLUDING ALL AMENDMENTS, EXCEPT WHERE VARIED BY THE CONTRACT DOCUMENTS.

4. ALL FIXTURES AND FITTINGS ARE TO BE INSTALLED IN STRICT ACCORDANCE WITH THE RELEVANT STANDARDS FOR 'DESIGN FOR ACCESS AND MOBILITY', IN PARTICULAR AS 1428.1 AND THE BUILDING CODE OF AUSTRALIA. 5. SURVEY/CONTOURS FROM SITE SURVEY BY BCE SURVEYING PTY LTD.

6. SERVICES, SUCH AS SEWER, WATER, GAS, COMMUNICATIONS, ELECTRICITY AND DRAINAGE SERVICES, MAY BE ENCOUNTERED DURING CONSTRUCTION OF THE WORKS. SERVICES INFORMATION SHOWN ON DRAWINGS IS INDICATIVE ONLY AND MAY NOT BE COMPLETE. BEFORE EXCAVATION COMMENCES THE LOCATION OF ALL SUCH SERVICES SHALL BE OBTAINED FROM THE RELEVANT AUTHORITIES BY THE CONTRACTOR.

7. THE CONTRACTOR SHALL CO-ORDINATE THE LOCATION OF ALL EXISTING AND PROPOSED SERVICES PRIOR TO COMMENCEMENT OF WORK. ANY CONFLICTS ARE TO BE REPORTED TO THE PROJECT SUPERVISOR IMMEDIATELY.

8. THE CONTRACTOR SHALL PROVIDE A SAFE WORKING ENVIRONMENT FOR THE DURATION OF THE WORKS. THE CONTRACTOR SHALL HAVE IN PLACE PROJECT SAFETY AND RISK MANAGEMENT SYSTEMS WHICH COMPLY WITH THE OCCUPATIONAL SAFETY AND HEALTH ACT AND WORK SAFE WA REQUIREMENTS.

9. THE CONTRACTOR SHALL LIMIT ACCESS TO THE WORKS TO THE SITEWORKS BOUNDARY. EXISTING VEGETATION ETC. OUTSIDE OF THE BOUNDARY TO BE

10. ALL TREES SHALL REMAIN UNDISTURBED UNLESS SPECIFICALLY NOTED ON THE PLANS OR ADVISED BY THE SHIRE

11. THE CONTRACTOR SHALL REMOVE FROM SITE ALL RUBBISH WITHIN THE SITEWORKS BOUNDARY TO AN APPROVED DISPOSAL SITE.

12. THE CONTRACTOR IS TO ENSURE THE STABILITY OF ALL STRUCTURES DURING ALL PHASES OF CONSTRUCTION.

14. ALL PROPOSED WORKS TO BE LOCATED ON SITE WITH SPOT PAINT AND APPROVED BY THE PROJECT SUPERVISOR, PRIOR TO COMMENCEMENT OF ANY WORK.

SITEWORKS NOTES:

1. ALL WORKS SHALL BE CONSTRUCTED IN ACCORDANCE WITH THE PROJECT SPECIFICATION, BUT WHERE NO DETAIL IS PROVIDED, TO THE REQUIREMENTS OF THE LOCAL AUTHORITY.

2. CONTRACTOR SHALL PROVIDE ALL SIGNING, LIGHTING AND FLAGMEN NECESSARY TO ENSURE SAFETY OF THE PUBLIC AND OF THE WORKS.

3. LOCATE ALL LEVELS FROM EXISTING SURVEY MARKS. ALL SURVEY MARKS SHALL BE PROTECTED.

ALE ZISTING VEGETATION SHALL NOT BE DISTURBED BEYOND THE EXTENT OF WORK.

5. ALL FILL SHALL BE CLEAN NON PLASTIC MATERIAL FREE FROM VEGETATION AND OTHER DELETERIOUS MATERIAL AND CERTIFIED AS SUITABLE FOR RESIDENTIAL LAND USE.

6. ALL FILL SHALL BE PLACED IN UNIFORM LAYERS NOT EXCEEDING 300mm THICKNESS AND COMPACTED TO A DENSITY NOT LESS THAN 95% MAXIMUM DRY DENSITY. 7. CONTRACTOR SHALL TIE IN OF NEW SURFACE TO FINISH FLUSH WITH EXISTING SURFACE.

CONTRACTOR SCOPE OF WORKS:

THE CONTRACTORS OBLIGATIONS LISTED BELOW INCLUDE, BUT ARE NOT LIMITED TO:

1. DESIGN AND CONSTRUCT THE BUILDING IN STRICT ACCORDANCE WITH THE SPECIFICATIONS AND RELEVANT STANDARDS.

2. PROVIDE A CERTIFICATE OF DESIGN COMPLIANCE.

3. APPLY FOR AND OBTAIN A BUILDING PERMIT. THE SHIRE OF DARDANUP WILL WAIVE THE APPLICATION FEE.

4. PROVIDE A CERTIFICATE OF CONSTRUCTION COMPLIANCE.

5. MAKE APPLICATION TO CONSTRUCT OR INSTALL AN APPARATUS FOR THE TREATMENT OF SEWAGE.

INSULATION:

1. ALL EXTERNAL AN INTERNAL STUD WALLS TO BE INSULATED WITH R2.5 INSULATION BATTS.
2. ALL CEILINGS TO BE INSULATED WITH R4.1 BATTS.
3. ALL ROOFS TO BE FITTED WITH 'AIR-CELL

GLARESHEILD' OR SIMILAR APPROVED.

4. BUILDING TO BE WRAPPED IN 'ENVIROSEAL PROCTORWRAP' OR SIMILAR APPROVED.
5. ALL INSULATION TO BE INSTALLED IN STRICT

ACCORDANCE WITH THE MANUFACTURER'S SPECIFICATIONS AND THE BCA.

INTERNAL FINISHES:

1. ALL INTERNAL DRY AREA WALLS TO BE CLAD WITH 13mm PLASTERBOARD.

2. ALL INTERNAL DRY AREA CEILINGS TO BE CLAD WITH 10mm PLASTERBOARD.

3. ALL INTERNAL WET AREA WALLS AND CEILINGS TO BE CLAD WITH 10mm MOISTURE RESISTANT PLASTERBOARD. REFER TO ROOM ELEVATIONS FOR EXTENT OF TILED FINISH

4. ALL INTERNAL DRY AREAS TO BE FITTED WITH 75mm COVE CORNICE. SELECTED PAINT FINISH.

5. ALL INTERNAL DRY AREAS TO BE FITTED WITH 68mm MDF SKIRTING BOARDS. PAINT FINISH WHITE GLOSS.
6. ALL WALL AND CEILING FINISHES TO BE INSTALLED IN STRICT ACCORDANCE WITH THE MANUFACTURER'S SPECIFICATIONS AND THE BCA.

FLOOR FINISHES:

1. FLOOR FINISHES TO THE EXISTING BUILDING ARE TO REMAIN AS IS. ALL CARE SHOULD BE TAKEN NOT TO DAMAGE THE EXISTING FLOORS DURING INSTALLATION OF THE BUILDING ELEMENTS.

2. ALL TOILETS TO HAVE NON SLIP TILED FLOORS
FINISHED TO FALLS AND GRADED TO WASTE.
3. FLOORS TO THE STORE, AIRLOCK, WASHROOM,
VEHICLE SHED AND EQUIPMENT STORE TO BE SEALED
CONCRETE WITH A NON SLIP FINISH.

4. ALL FLOOR FINISHES TO BE INSTALLED IN STRICT ACCORDANCE WITH THE MANUFACTURER'S SPECIFICATIONS AND THE BCA.

TERMITE TREATMENT:

1.PROVIDE APPROVED CHEMICAL OR BARRIER TERMITE TREATMENT TO THE UNDERSIDE AND PERIMETER OF ALL FLOOR SLABS.

2. INSTALL ANTI TERMITE SLEEVES TO ALL SERVICES WHICH PENETRATE THE SLAB.

3. ALL TREATMENTS TO BE INSTALLED IN STRICT ACCORDANCE WITH THE MANUFACTURER'S SPECIFICATIONS. THE BCA AND AS.3660.

FIRE SAFETY:

1. PORTABLE FIRE EXTINGUISHERS TO BE INSTALLED IN STRICT ACCORDANCE WITH AS 2444 AND THE BCA.
2. SMOKE ALARMS TO BE INSTALLED IN STRICT ACCORDANCE WITH AS .3786 AND THE BCA.

ELECTRICAL:

1. ALL ELECTRICAL WORK TO BE CARRIED OUT IN STRICT ACCORDANCE WITH ALL RELEVANT AUSTRALIAN STANDARDS AND THE BCA.

2. SUPPLY EMERGENCY LIGHTING INSTALLED IN STRICT ACCORDANCE WITH THE MANUFACTURER'S SPECIFICATIONS TO COMPLY WITH AS.2229 AND THE BCA.
3. INSTALL RCD'S TO ALL WIRING CIRCUITS IN STRICT ACCORDANCE WITH AS.3000.

PLUMBING:

1. ALL PLUMBING WORK TO BE CARRIED OUT IN STRICT ACCORDANCE WITH ALL RELEVANT AUSTRALIAN STANDARDS AND THE BCA.

2. APPROVED SEPTIC SYSTEM TO BE INSTALLED TO THE SATISFACTION OF THE SHIRE OF DARDANUP HEALTH DEPARTMENT.

3. SPECIFIED RAINWATER TANK TO BE INSTALLED IN STRICT ACCORDANCE WITH THE MANUFACTURER'S SPECIFICATIONS. INSTALL APPROVED PUMP AS REQUIRED TO SUPPLY WATER FROM THE TANK TO THE FIXTURES INDICATED ON THE DRAWINGS. PRESSURE WITHIN THE BUILDING TO BE WITHIN PLUMBING CODE STANDARDS. NO PRESSURE RAISING DEVICES ARE TO BE INSTALLED.

A. ALL DOWNPIPES TO BE FITTED WITH STAND-OFF CLIPS AND LEAF DIVERTERS. CONNECT ALL DOWNPIPES TO RAINWATER TANK WITH CHARGED LINE.


5. APPROVED INSTANTANEOUS ELECTRICAL HOT WATER SYSTEM TO BE INSTALLED AS REQUIRED TO SUPPLY HOT WATER TO THE FIXTURES INDICATED ON THE DRAWINGS. SECURITY:

1. INSTALL MOTION DETECTING ALARMED SECURITY SYSTEM TO THE EXISTING BUILDING AND THE EXTENSIONS. PROPOSED ALARM SYSTEM TO BE SUBMITTED TO THE SHIRE OF DARDANUP FOR APPROVAL PRIOR TO INSTALLATION. REFER TO ELECTRICAL PLAN FOR LOCATION OF MOTION DETECTORS / CAMERAS.
2. ALARM SYSTEM TO COMPLY WITH ALL RELEVANT AUSTRALIAN STANDARDS AND REGULATIONS.
3. PROVIDE STEEL WINDOW BAR SECURITY SCREENS FIXED TO FACE OF BUILDING STRUCTURE. APPLY TO ALL EXISTING AND NEW EXTERNAL WINDOWS.
MIN. VERTICAL CTS. OF BARS 100mm - MAX. 150mm.
TO BE ADEQUATELY TREATED FOR MAXIMUM CORROSION RESISTANCE. COLORBOND 'BUSHLAND' FINISH.



_										
	AMENDMENT DESCRIPTION	BY	DATE	APPROVED	REVIEWED FOR CONSTRUCTION AUTHORISED FOR APPROVAL	APPROVED FOR CONSTRUCTION	DRAWING TITLE			
							PROPOSED ADDITIONS TO	INFRASTRUCTURE		The same of the sa
						TARDIS RECORD NUMBER	FERGUSON VOLUNTEER BUSH FIRE BRIGADE	INTRASTRUCTURE		>
					B.B. 06.03.2025		FERGUSUN VOLUNTEER BUSH FIRE BRIGADE		Shira of D	100
					THIS DRAWING IS AND SHALL REMAIN THE SOLE	PROPERTY OF	GENERAL NOTES	DRAWING NO.	131 III O L)ar
					THE SHIRE OF DARDANUP'. THE DRAWING MAY		GENERAL NOTES	2025-BDG-123-11		
_					THE PURPOSE FOR WHICH IT WAS COMMISIONE	,		2020 000 120 11		Telephone Facsimile
			-		LENT, SHOWN, COPIED OR OTHERWISE DUPLICATION OF THE OWNER.	ATED WITHOUT THE		DATUM. AHD SHEET NO. SHEET SIZE	-	Online
- 1				1	WRITTEN AUTHORISATION OF THE OWNER.			GRID SYSTEM GDA94	ABN: 57 305 829 653	



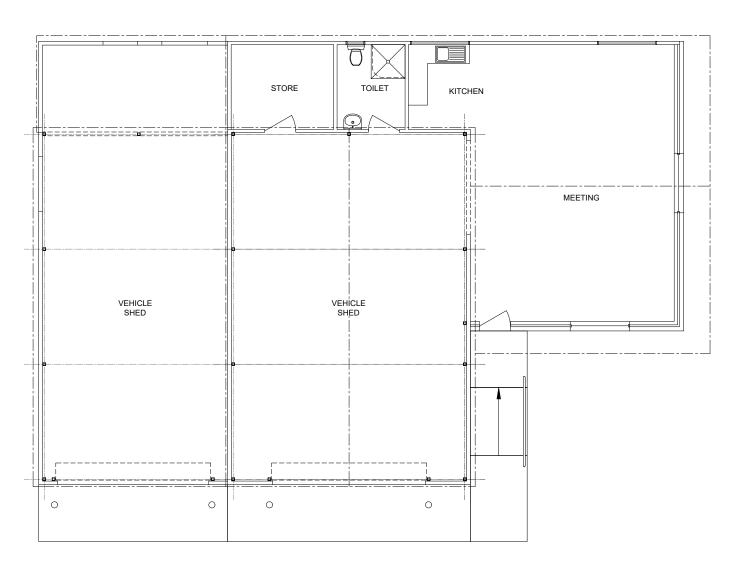


EXISTING FLOOR PLAN

SCALE; 1:100		тирини	пПпп	шЩшш	шПпш	ПП
at A3	0	1m	2	3	4	5




AMENDMENT DESCRIPTION	BY	DATE	APPROVED	REVIEWED FOR CONSTRUCTION	AUTHORISED FOR APPROVAL	APPROVED FOR CONSTRUCTIO	DRAWING TITLE							
A ISSUED FOR COMMENT	B.B.	11.03.2025					PROPOSED INTERNAL MODIFICATIONS TO		1	NFRASTRUCTURI	=			
				DRAWN	DRAWN DATE	TARDIS RECORD NUMBER			ı	INI INASTINUCTURI	_			к.
				⊣в.в.	10.03.2025		FERGUSON VOLUNTEER BUSH FIRE BRIGADE					Claire	Danalana	_
				THIS DRAWING IS AND	SHALL REMAIN THE SOL	E DDODEDTY OF	EVICTING FLOOR PLAN			DRAWING NO.		TShire of	Dardanu	\mathbf{C}
					NUP'. THE DRAWING MAY		EXISTING FLOOR PLAN		20	00E DDC 404 C	14		Dai dai la	_
					HICH IT WAS COMMISION				20)25-BDG-124-0	<i>!</i>	Administration Centre Eaton	Telephone 08 9724 0000	
					OR OTHERWISE DUPLIC					0.1557.110		P.O Box 7017- 1 Council Drive	Facsimile 08 9724 0091	
				WRITTEN AUTHORISAT				DATUM.	AHD	SHEET NO.	SHEET SIZE	Eaton Western Australia 6232	Online www.dardanup.wa.	.v.au



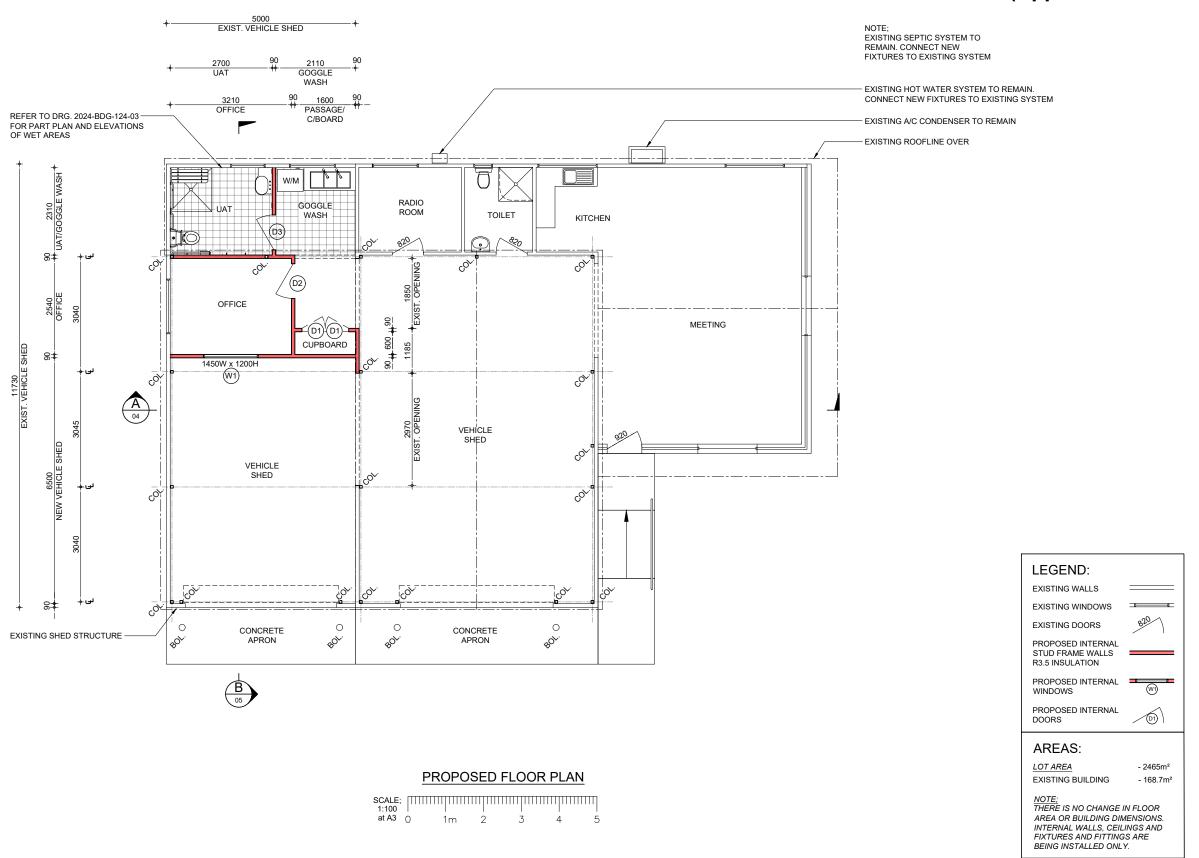



	AWENDWENT DESCRIPTION	B1	DATE	APPROVED	THE VIEWED I ON CONCINCOTION	AUTHORIGED FOR ALT ROVAL	APPROVED FOR CONSTRUCTION	DRAWING TILE					THE RESERVE OF THE PARTY OF THE
	A ISSUED FOR COMMENT	B.B.	11.03.2025					PROPOSED INTERNAL MODIFICATIONS TO		INFRASTRUCTUR	E		
					DRAWN	DRAWN DATE	TARDIS RECORD NUMBER			INITASTINUCTUR	_		
\vdash			+		B.B.	10.03.2025		FERGUSON VOLUNTEER BUSH FIRE BRIGADE				Claire	
-					THE PRANTING IS AND	OLIALL DEMAIN THE COLE	DDODEDTY OF			DRAWING NO.		ishire of I	I Jardani ini
						SHALL REMAIN THE SOLE		PROPOSED FLOOR PLAN		000E DDO 404 (Dai dai lap
					THE PURPOSE FOR WH	NUP'. THE DRAWING MAY				2025-BDG-124-0	12	Administration Centre Eaton	Telephone 08 9724 0000
						OR OTHERWISE DUPLICA						P.O Box 7017- 1 Council Drive	Facsimile 08 9724 0091
-			+		WRITTEN AUTHORISAT		AILD WIIIIOUI INE		DATUM. AHD	SHEET NO.	SHEET SIZE	Eaton Western Australia 6232	Online www.dardanup.wa.gov.au
					I WKILLEN AUTHORISAT	ION OF THE OWNER.			ODID OVOTELL OD		SHEET SIZE	4 044 57 005 000 050	

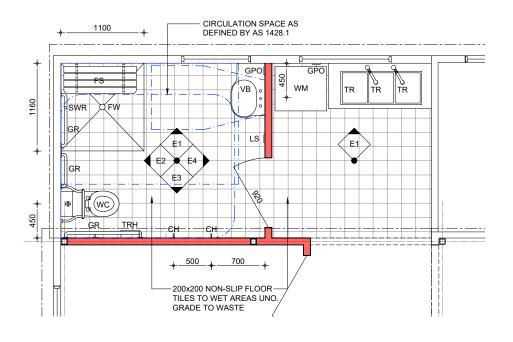

PART PLAN - WET AREA


LEGEND:

VB - VANITY BASIN
GR - GRAB RAIL
WC - WATER CLOSET
UR - URINAL
FW - FLOOR WASTE
FS - FOLDING SEAT
CH - CLOTHES HOOK
SH - SHELF
MI - MIRROR
WM - WASHING MACHINE
TR - TROUGH
SWR - SHOWER
SCR - SHOWER CURTAIN RAIL
TRH - TOILET ROLL HOLDER
LS - LIGHT SWITCH
GPO - GENERAL PURPOSE OUTLET


NOTE:


1. PROVIDE APPROVED PAPER TOWEL
DISPENSER AND SOAP DISPENSER TO ALL
TOILETS IN STRICT ACCORDANCE WITH THE
BCA AND AS 1428.1.


2. ALL ITEMS AND ELEMENTS FORMING PART
OF THE WET AREAS SHALL BE IN STRICT
ACCORDANCE WITH THE BCA AND AS 1428.1.

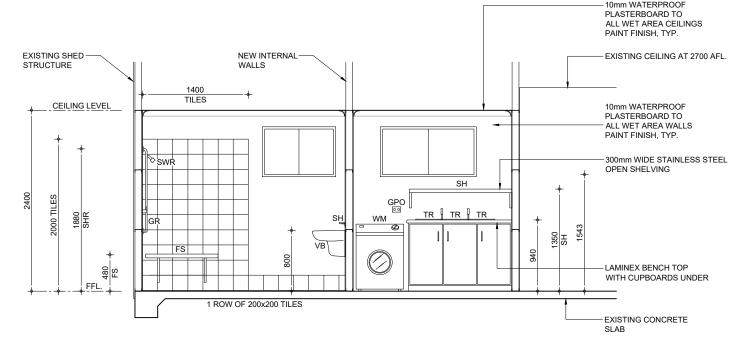

INTERNAL ELEVATION E1

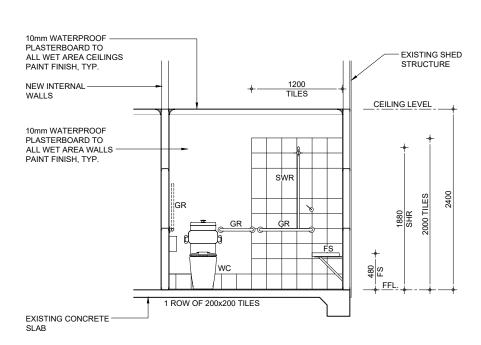

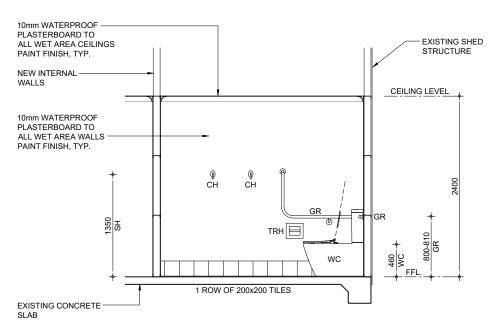

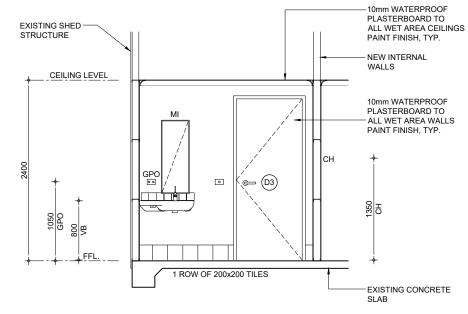


INTERNAL ELEVATION E2

INTERNAL ELEVATION E3

INTERNAL ELEVATION E4




	AMENDMENT DESCRIPTION	BY	DATE	APPROVED	REVIEWED FOR CONSTRUCTION AUTHORISED FOR APPROVAL	APPROVED FOR CONSTRUCTION	DRAWING TITLE		
Α	ISSUED FOR COMMENT	B.B.	11.03.2025				PROPOSED INTERNAL MODIFICATIONS TO	INFRASTRUCTURE	
					DRAWN DATE	TARDIS RECORD NUMBER	FERGUSON VOLUNTEER BUSH FIRE BRIGADE	INITAGINOCIONE	
					B.B. 10.03.2025		FERGUSUN VULUNTEER BUSH FIRE BRIGADE		Shire of Dardanun
					\dashv THIS DRAWING IS AND SHALL REMAIN THE SOL	E PROPERTY OF	UAT PART PLAN AND ELEVATIONS	DRAWING NO.	15hire of Dardanub
					'THE SHIRE OF DARDANUP'. THE DRAWING MAY		UAT PART PLAN AND ELEVATIONS	2025-BDG-124-03	
					THE PURPOSE FOR WHICH IT WAS COMMISION	ED, AND MAY NOT BE			Administration Centre Eaton Telephone 08 9724 0000
					LENT, SHOWN, COPIED OR OTHERWISE DUPLIC	ATED WITHOUT THE		DATUM AHD SHEET NO.	P.O Box 7017- 1 Council Drive Facsimile 08 9724 0091 Eaton Western Australia 6232 Online www.dardanup.wa.gov.au
					WRITTEN AUTHORISATION OF THE OWNER.			CRID SYSTEM CDAGA	APAL 57 205 220 652

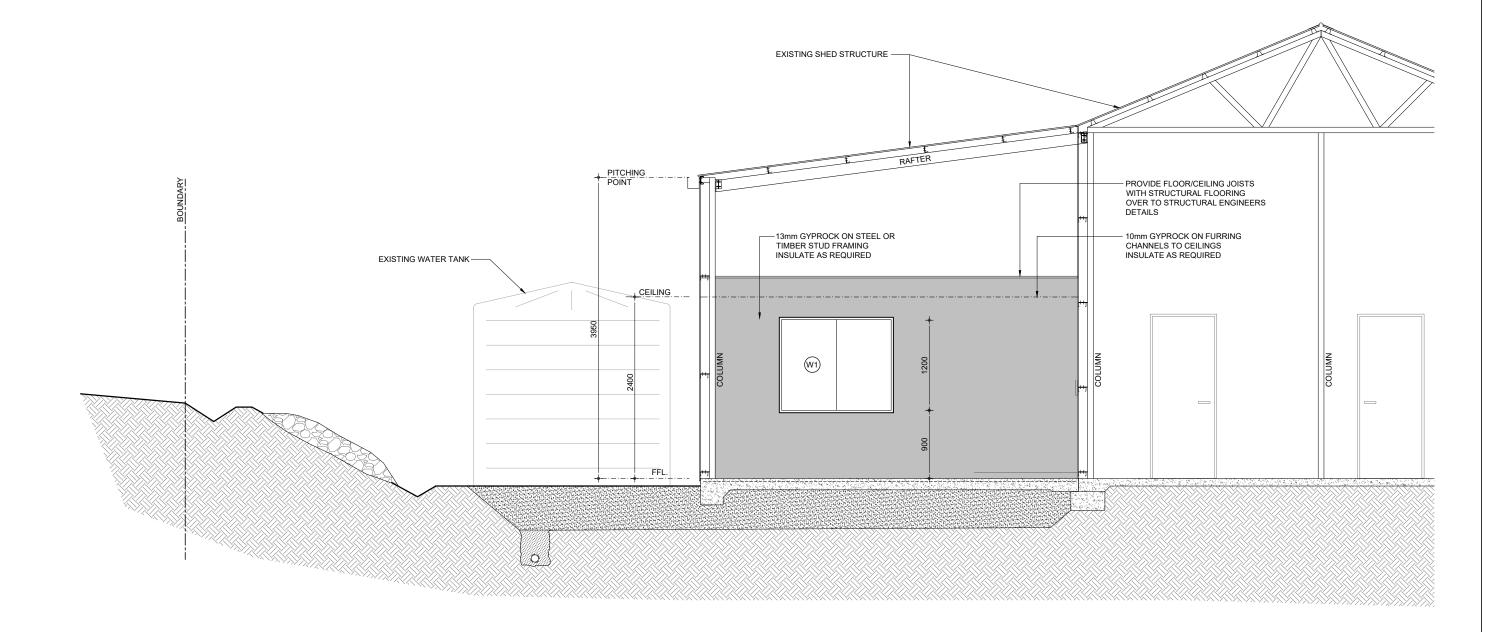





	AMENDMENT DESCRIPTION	BY !	DATE	APPROVED	REVIEWED FOR CONSTRUCTION	N AUTHORISED FOR APPROVAL	APPROVED FOR CONSTRUCTION	DRAWING TITLE						THE PARTY NAMED IN	
Α	ISSUED FOR COMMENT	B.B.	11.03.2025					PROPOSED INTERNAL MODIFICATIONS TO		INIE	FRASTRUCTURE	:			
		· · · · · · · · · · · · · · · · · · ·			DRAWN	DRAWN DATE	TARDIS RECORD NUMBER	FERGUSON VOLUNTEER BUSH FIRE BRIGADE		IINI	NASTROCTORE	-			
					B.B.	10.03.2025		FERGOSON VOLUNTEER BOSTI FIRE BRIGADE					Chira of	Dar	بمامه
					THIS DRAWING IS AND	SHALL REMAIN THE SOLE	PROPERTY OF	SECTION A			DRAWING NO.		ishire of	Dali	Udl
					THE SHIRE OF DARDA	NUP'. THE DRAWING MAY	ONLY BE USED FOR	SECTION A		202	5-BDG-124-04	1	0 0 .		0.0
		'			THE PURPOSE FOR WI	HICH IT WAS COMMISIONE	D, AND MAY NOT BE			202	3-DDG-124-0	7	Administration Centre Eaton		08 9724 0
		. '			LENT, SHOWN, COPIED	D OR OTHERWISE DUPLICA	ATED WITHOUT THE				SHEET NO.		P.O Box 7017- 1 Council Drive		08 9724 0
					WRITTEN AUTHORISAT	TION OF THE OWNER.			DATUM.	AHD	SHEET NO.	SHEET SIZE	Eaton Western Australia 6232	Online	www.dard
			1	1	1				CRID SYSTEM			1	ARN: 57 305 829 653		

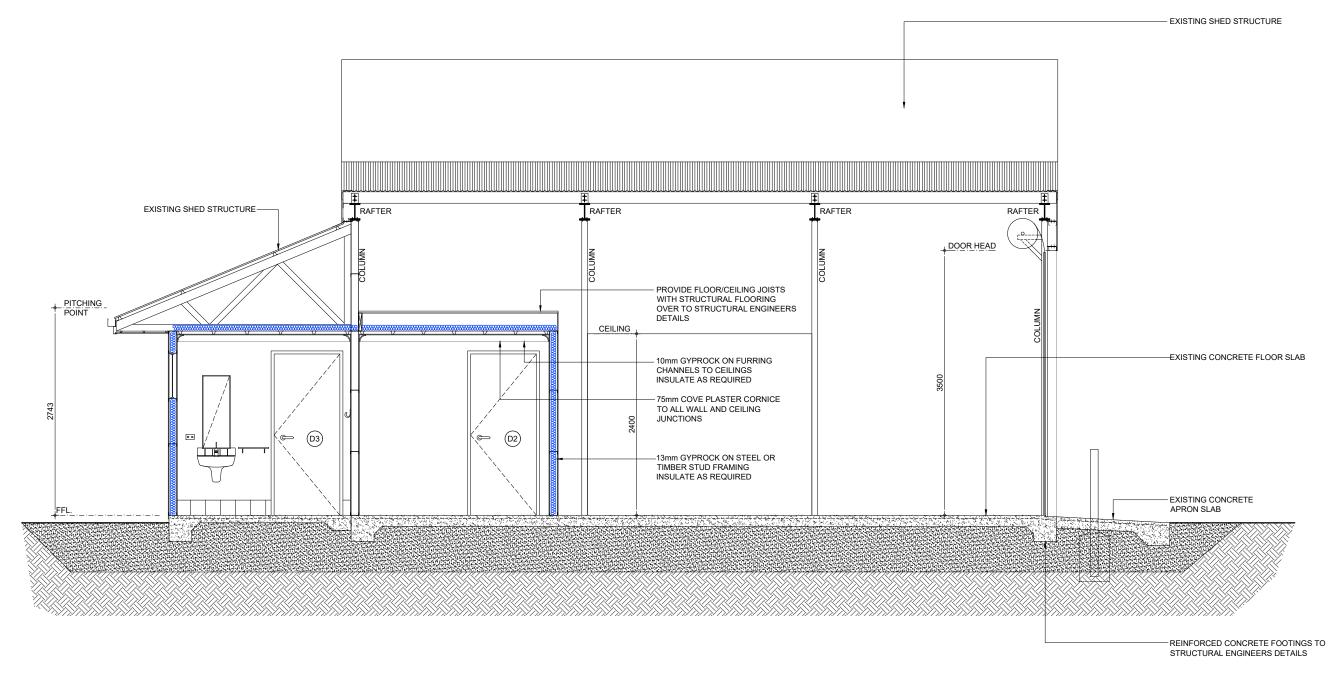





	AMENDMENT DESCRIPTION	BY	DATE	APPROVED	REVIEWED FOR CONSTRUCTION	AUTHORISED FOR APPROVAL	APPROVED FOR CONSTRUCTION	DRAWING TITLE					THE REAL PROPERTY.
Α	ISSUED FOR COMMENT	B.B.	11.03.2025					PROPOSED INTERNAL MODIFICATIONS TO	INFRAS	STRUCTURE			
					DRAWN	DRAWN DATE	TARDIS RECORD NUMBER	FERGUSON VOLUNTEER BUSH FIRE BRIGADE		OTTOOTOTE			_
					B.B.	10.03.2025		FERGUSUN VOLUNTEER BUSH FIRE BRIGADE				Chira of I	
					THIS DRAWING IS AND	SHALL REMAIN THE SOLE	PROPERTY OF	SECTION B		DRAWING NO.		ishire ot l	Jc
					THE SHIRE OF DARDA	NUP'. THE DRAWING MAY	ONLY BE USED FOR	SECTION B	2025_R	3DG-124-05		0 0	
					THE PURPOSE FOR WI	HICH IT WAS COMMISIONE	D, AND MAY NOT BE		2025-0	00-124-03		Administration Centre Eaton	Teleph
						OR OTHERWISE DUPLICA	ATED WITHOUT THE		DATUM. AHD	SHEET NO.		P.O Box 7017- 1 Council Drive Eaton Western Australia 6232	Facsim Online
					WRITTEN AUTHORISAT	ION OF THE OWNER.			GRID SYSTEM GDA94	SH	HEET SIZE	ABN: 57 305 829 653	Cilline

DOOR SCHEDULE: DOOR NUMBER TOTAL DOOR TYPE PANEL TYPE PANEL FINISH FRAME TYPE FRAME FINISH HEIGHT WIDTH ADDITIONAL INFORMATION / COMMENTS D1 INTERNAL SWING SOLID CORE PAINT FINISH PAINT FINISH 2040mm 620mm 'D' TYPE HARDWARE TO BE INSTALLED IN ACCORDANCE WITH THE NCC AND AS 1428.1. STEEL DOOR PLY FACE GLOSS WHITE **GLOSS WHITE** SOLID CORE PAINT FINISH STEEL PAINT FINISH D2 INTERNAL SWING 920mm 'D' TYPE HARDWARE TO BE INSTALLED IN ACCORDANCE WITH THE NCC AND AS 1428.1. 1 2040mm PLY FACE **GLOSS WHITE GLOSS WHITE** DOOR D3 1 INTERNAL SWING SOLID CORE PAINT FINISH STEEL PAINT FINISH 2040mm 920mm LEVER ACTION HARDWARE AND SIGNAGE TO BE INSTALLED IN STRICT ACCORDANCE WITH THE NCC AND AS 1428.1. DOOR PLY FACE **GLOSS WHITE GLOSS WHITE** WINDOW SCHEDULE: ADDITIONAL INFORMATION / COMMENTS WINDOW NUMBER TOTAL WINDOW TYPE FRAME TYPE FRAME FINISH GLAZING HEAD SILL W1 1450W x 1200H PROPRIETARY POWDERCOATED CLEAR SINGLE 2143mm AFL 1586mm AFL INSTALL STEEL WINDOW BAR SECURITY SCREENS FIXED TO FACE OF BUILDING STRUCTURE. MIN. VERTICAL CTS. OF BARS 100mm - MAX. 150mm. FRAMES TO BE ADEQUATELY TREATED FOR SLIDING WINDOW ALUMINIUM FRAMES GLAZING COLORBOND -'CLASSIC CREAM' MAXIMUM CORROSION RESISTANCE. COLORBOND 'BUSHLAND' FINISH.

DOOR NOTES:

BY

DATE

- 1) CONTRACTOR TO SUPPLY AND INSTALL KEY LOCK MECHANISMS TO ALL EXTERNAL DOORS AND AS NOTED IN THE SCHEDULE.
- 2) CONTRACTOR TO SUPPLY AND INSTALL LOCKING MECHANISMS TO ALL BATHROOM AND TOILET DOORS. FITMENTS TO UAT TO BE IN STRICT ACCORDANCE WITH AS 1428.1.
- 3) CONTRACTOR TO SUPPLY AND INSTALL LIFT OFF HINGES TO ALL BATHROOM AND TOILET DOORS IN STRICT ACCORDANCE WITH THE BCA.
- 4) CONTRACTOR TO SUPPLY AND INSTALL ALL NECESSARY DOOR HARDWARE.
- 5) REFER TO FLOOR PLAN FOR DOOR ORIENTATION.

WINDOW NOTES:

- 1) CONTRACTOR TO SUPPLY AND INSTALL KEY LOCK MECHANISMS TO ALL EXTERNAL WINDOWS.
- 2) CONTRACTOR TO SUPPLY AND INSTALL ALL NECESSARY WINDOW HARDWARE.
- 3) CONTRACTOR TO SUPPLY AND INSTALL WINDOW BAR SECURITY SCREENS.
- 4) REFER TO ELEVATIONS FOR WINDOW SLIDING DIRECTION.



	A ISSUED FOR COMMENT	B.B.	11.03.2025				PROPOSED INTERNAL MODIFICATIONS TO		INFR	ASTRUCTURE	=			
				DRAWN	DRAWN DATE	TARDIS RECORD NUMBER			11 11 17	ASTRUCTURE	_			
⊢				B.B.	10.03.2025		FERGUSON VOLUNTEER BUSH FIRE BRIGADE					CI. C		
-				THE DRAWING IS AND	SHALL REMAIN THE SOL	E DDODEDTY OF				DRAWING NO.		TYNIRA OT	1)ard	iani int
					SHALL REMAIN THE SOL NUP'. THE DRAWING MAY		WINDOW AND DOOR SCHEDULE		0005	DDO 404 0			Dara	
					HICH IT WAS COMMISION				2025-	-BDG-124-0	O	Administration Centre Eaton	Telephone 0	08 9724 0000
					OR OTHERWISE DUPLIC							P.O Box 7017- 1 Council Drive	Facsimile 0	08 9724 0091
H				WRITTEN AUTHORISAT		WILD WILLOOF THE		DATUM.	AHD	SHEET NO.	SHEET SIZE	Eaton Western Australia 6232	Online w	www.dardanup.wa.gov.au

APPROVED REVIEWED FOR CONSTRUCTION AUTHORISED FOR APPROVAL APPROVED FOR CONSTRUCTION DRAWING TITLE

VERTICAL DATUM: AUSTRALIAN HEIGHT DATUM (AHD) HORIZONTAL DATUM: GDA94 / MGA zone 50

1. DO NOT SCALE FROM THE DRAWINGS. ALL DIMENSIONS ARE TO THE FACE OF FRAMING OR STRUCTURE. ANY DISCREPANCIES ARE TO BE REFERRED TO THE PROJECT SUPERVISOR FOR A DECISION PRIOR TO COMMENCEMENT OF ANY WORK.

2. THESE DRAWINGS ARE TO BE READ IN CONJUNCTION WITH ALL OTHER CONSULTANTS DRAWINGS AND SPECIFICATIONS.

3. WORKMANSHIP AND MATERIALS ARE TO BE IN ACCORDANCE WITH THE RELEVANT S.A.A. CODES AND THE LOCAL STATUTORY AUTHORITIES REGULATIONS INCLUDING ALL AMENDMENTS, EXCEPT WHERE VARIED BY THE CONTRACT DOCUMENTS.

4. ALL FIXTURES AND FITTINGS ARE TO BE INSTALLED IN STRICT ACCORDANCE WITH THE RELEVANT STANDARDS FOR 'DESIGN FOR ACCESS AND MOBILITY', IN PARTICULAR AS 1428.1 AND THE BUILDING CODE OF AUSTRALIA. 5. SURVEY/CONTOURS FROM SITE SURVEY BY BCE SURVEYING PTY LTD.

6. SERVICES, SUCH AS SEWER, WATER, GAS, COMMUNICATIONS, ELECTRICITY AND DRAINAGE SERVICES, MAY BE ENCOUNTERED DURING CONSTRUCTION OF THE WORKS. SERVICES INFORMATION SHOWN ON DRAWINGS IS INDICATIVE ONLY AND MAY NOT BE COMPLETE. BEFORE EXCAVATION COMMENCES THE LOCATION OF ALL SUCH SERVICES SHALL BE OBTAINED FROM THE RELEVANT AUTHORITIES BY THE CONTRACTOR.

7. THE CONTRACTOR SHALL CO-ORDINATE THE LOCATION OF ALL EXISTING AND PROPOSED SERVICES PRIOR TO COMMENCEMENT OF WORK. ANY CONFLICTS ARE TO BE REPORTED TO THE PROJECT SUPERVISOR IMMEDIATELY. 8. THE CONTRACTOR SHALL PROVIDE A SAFE WORKING ENVIRONMENT FOR THE DURATION OF THE WORKS. THE CONTRACTOR SHALL HAVE IN PLACE PROJECT SAFETY AND RISK MANAGEMENT SYSTEMS WHICH COMPLY WITH THE OCCUPATIONAL SAFETY AND HEALTH ACT AND WORK SAFE WA REQUIREMENTS.

9. THE CONTRACTOR SHALL LIMIT ACCESS TO THE WORKS TO THE SITEWORKS BOUNDARY. EXISTING VEGETATION ETC. OUTSIDE OF THE BOUNDARY TO BE

10. ALL TREES SHALL REMAIN UNDISTURBED UNLESS SPECIFICALLY NOTED ON THE PLANS OR ADVISED BY THE SHIRE

11. THE CONTRACTOR SHALL REMOVE FROM SITE ALL RUBBISH WITHIN THE SITEWORKS BOUNDARY TO AN APPROVED DISPOSAL SITE.

12. THE CONTRACTOR IS TO ENSURE THE STABILITY OF ALL STRUCTURES DURING ALL PHASES OF CONSTRUCTION.

14. ALL PROPOSED WORKS TO BE LOCATED ON SITE WITH SPOT PAINT AND APPROVED BY THE PROJECT SUPERVISOR, PRIOR TO COMMENCEMENT OF ANY WORK.

SITEWORKS NOTES:

1. ALL WORKS SHALL BE CONSTRUCTED IN ACCORDANCE WITH THE PROJECT SPECIFICATION, BUT WHERE NO DETAIL IS PROVIDED, TO THE REQUIREMENTS OF THE LOCAL AUTHORITY.

2. CONTRACTOR SHALL PROVIDE ALL SIGNING, LIGHTING AND FLAGMEN NECESSARY TO ENSURE SAFETY OF THE PUBLIC AND OF THE WORKS.

3. LOCATE ALL LEVELS FROM EXISTING SURVEY MARKS. ALL SURVEY MARKS SHALL BE PROTECTED.

ALE SURVEY WARMS SHALL BE FROTECTED.

4. EXISTING VEGETATION SHALL NOT BE DISTURBED BEYOND THE EXTENT OF WORK.

5. ALL FILL SHALL BE CLEAN NON PLASTIC MATERIAL FREE FROM VEGETATION AND OTHER DELETERIOUS MATERIAL AND CERTIFIED AS SUITABLE FOR RESIDENTIAL LAND

6. ALL FILL SHALL BE PLACED IN UNIFORM LAYERS NOT EXCEEDING 300mm THICKNESS AND COMPACTED TO A DENSITY NOT LESS THAN 95% MAXIMUM DRY DENSITY. 7. CONTRACTOR SHALL TIE IN OF NEW SURFACE TO FINISH FLUSH WITH EXISTING SURFACE.

CONTRACTOR SCOPE OF WORKS:

THE CONTRACTORS OBLIGATIONS LISTED BELOW INCLUDE, BUT ARE NOT LIMITED TO:

1. DESIGN AND CONSTRUCT THE BUILDING IN STRICT ACCORDANCE WITH THE SPECIFICATIONS AND RELEVANT STANDARDS.

2. PROVIDE A CERTIFICATE OF DESIGN COMPLIANCE.

3. APPLY FOR AND OBTAIN A BUILDING PERMIT. THE SHIRE OF DARDANUP WILL WAIVE THE APPLICATION FEE.

4. PROVIDE A CERTIFICATE OF CONSTRUCTION COMPLIANCE.

5. MAKE APPLICATION TO CONSTRUCT OR INSTALL AN APPARATUS FOR THE TREATMENT OF SEWAGE.

INSULATION:

1. ALL EXTERNAL AN INTERNAL STUD WALLS TO BE INSULATED WITH R2.5 INSULATION BATTS.
2. ALL CEILINGS TO BE INSULATED WITH R4.1 BATTS.

2. ALL CEILINGS TO BE INSULATED WITH R4.1 BATTS.
3. ALL ROOFS TO BE FITTED WITH 'AIR-CELL

GLARESHEILD' OR SIMILAR APPROVED.

4. BUILDING TO BE WRAPPED IN 'ENVIROSEAL

PROCTORWRAP' OR SIMILAR APPROVED.
5. ALL INSULATION TO BE INSTALLED IN STRICT
ACCORDANCE WITH THE MANUFACTURER'S
SPECIFICATIONS AND THE BCA.

INTERNAL FINISHES:

1. ALL INTERNAL DRY AREA WALLS TO BE CLAD WITH 13mm PLASTERBOARD.

2. ALL INTERNAL DRY AREA CEILINGS TO BE CLAD WITH 10mm PLASTERBOARD.

3. ALL INTERNAL WET AREA WALLS AND CEILINGS TO BE CLAD WITH 10mm MOISTURE RESISTANT PLASTERBOARD. REFER TO ROOM ELEVATIONS FOR EXTENT OF TILED FINISH

4. ALL INTERNAL DRY AREAS TO BE FITTED WITH 75mm COVE CORNICE. SELECTED PAINT FINISH.

5. ALL INTERNAL DRY AREAS TO BE FITTED WITH 68mm MDF SKIRTING BOARDS. PAINT FINISH WHITE GLOSS. 6. ALL WALL AND CEILING FINISHES TO BE INSTALLED IN STRICT ACCORDANCE WITH THE MANUFACTURER'S SPECIFICATIONS AND THE BCA.

FLOOR FINISHES:

1. FLOOR FINISHES TO THE EXISTING BUILDING ARE TO REMAIN AS IS. ALL CARE SHOULD BE TAKEN NOT TO DAMAGE THE EXISTING FLOORS DURING INSTALLATION OF THE BUILDING ELEMENTS.

2. ALL TOILETS TO HAVE NON SLIP TILED FLOORS
FINISHED TO FALLS AND GRADED TO WASTE.
3. FLOORS TO THE STORE, AIRLOCK, WASHROOM,
VEHICLE SHED AND EQUIPMENT STORE TO BE SEALED

CONCRETE WITH A NON SLIP FINISH.

4. ALL FLOOR FINISHES TO BE INSTALLED IN STRICT ACCORDANCE WITH THE MANUFACTURER'S SPECIFICATIONS AND THE BCA.

TERMITE TREATMENT:

1.PROVIDE APPROVED CHEMICAL OR BARRIER TERMITE TREATMENT TO THE UNDERSIDE AND PERIMETER OF ALL FLOOR SLABS.

2. INSTALL ANTI TERMITE SLEEVES TO ALL SERVICES WHICH PENETRATE THE SLAB.

3. ALL TREATMENTS TO BE INSTALLED IN STRICT ACCORDANCE WITH THE MANUFACTURER'S SPECIFICATIONS. THE BCA AND AS.3660.

FIRE SAFETY:

1. PORTABLE FIRE EXTINGUISHERS TO BE INSTALLED IN STRICT ACCORDANCE WITH AS.2444 AND THE BCA. 2. SMOKE ALARMS TO BE INSTALLED IN STRICT ACCORDANCE WITH AS.3786 AND THE BCA.

GENERAL NOTES

(Appendix ORD: 12.4.3B)

ELECTRICAL:

1. ALL ELECTRICAL WORK TO BE CARRIED OUT IN STRICT ACCORDANCE WITH ALL RELEVANT AUSTRALIAN STANDARDS AND THE BCA.

2. SUPPLY EMERGENCY LIGHTING INSTALLED IN STRICT ACCORDANCE WITH THE MANUFACTURER'S SPECIFICATIONS TO COMPLY WITH AS.2229 AND THE BCA.
3. INSTALL RCD'S TO ALL WIRING CIRCUITS IN STRICT ACCORDANCE WITH AS.3000.

PLUMBING:

1. ALL PLUMBING WORK TO BE CARRIED OUT IN STRICT ACCORDANCE WITH ALL RELEVANT AUSTRALIAN STANDARDS AND THE BCA.

2. APPROVED SEPTIC SYSTEM TO BE INSTALLED TO THE SATISFACTION OF THE SHIRE OF DARDANUP HEALTH DEPARTMENT.

3. SPECIFIED RAINWATER TANK TO BE INSTALLED IN STRICT ACCORDANCE WITH THE MANUFACTURER'S SPECIFICATIONS. INSTALL APPROVED PUMP AS REQUIRED TO SUPPLY WATER FROM THE TANK TO THE FIXTURES INDICATED ON THE DRAWINGS. PRESSURE WITHIN THE BUILDING TO BE WITHIN PLUMBING CODE STANDARDS. NO PRESSURE RAISING DEVICES ARE TO BE INSTALLED.

4. ALL DOWNPIPES TO BE FITTED WITH STAND-OFF CLIPS AND LEAF DIVERTERS. CONNECT ALL DOWNPIPES TO RAINWATER TANK WITH CHARGED LINE.

5. APPROVED INSTANTANEOUS ELECTRICAL HOT WATER SYSTEM TO BE INSTALLED AS REQUIRED TO SUPPLY HOT WATER TO THE FIXTURES INDICATED ON THE DRAWINGS. SECURITY:

1. INSTALL MOTION DETECTING ALARMED SECURITY SYSTEM TO THE EXISTING BUILDING AND THE EXTENSIONS. PROPOSED ALARM SYSTEM TO BE SUBMITTED TO THE SHIRE OF DARDANUP FOR APPROVAL PRIOR TO INSTALLATION. REFER TO ELECTRICAL PLAN FOR LOCATION OF MOTION DETECTORS / CAMERAS.

2. ALARM SYSTEM TO COMPLY WITH ALL RELEVANT AUSTRALIAN STANDARDS AND REGULATIONS.

3. PROVIDE STEEL WINDOW BAR SECURITY SCREENS FIXED TO FACE OF BUILDING STRUCTURE. APPLY TO ALL EXISTING AND NEW EXTERNAL WINDOWS.

MIN. VERTICAL CTS. OF BARS 100mm - MAX. 150mm.

TO BE ADEQUATELY TREATED FOR MAXIMUM CORROSION RESISTANCE. COLORBOND 'BUSHLAND' FINISH.



Α	ISSUED FOR COMMENT	B.B.	11.03.2025			
				DRAWN	DRAWN DATE	TARDIS RECORD NUMBER
				B.B.	10.03.2025	
_				TING DRAWING IO AND		DDODEDTI/OF
					SHALL REMAIN THE SOLE	
					IUP'. THE DRAWING MAY (
_				THE PURPOSE FOR WH	ICH IT WAS COMMISIONE	D, AND MAY NOT BE
				LENT, SHOWN, COPIED	OR OTHERWISE DUPLICA	TED WITHOUT THE
				WRITTEN AUTHORISATI	ON OF THE OWNER.	

DATE APPROVED REVIEWED FOR CONSTRUCTION AUTHORISED FOR APPROVAL APPROVED FOR CONSTRUCTION

PROPOSED INTERNAL MODIFICATIONS TO FERGUSON VOLUNTEER BUSH FIRE BRIGADE

INFRASTRUCTURE

2025-BDG-124-07

RID SYSTEM GDA94



Administration Centre Eaton
P.O Box 7017- 1 Council Drive
Eaton Western Australia 6232
ABN: 57 305 829 653

Telephone 08 9724 0000
Facsimile 08 9724 0091
Online www.dardanup

RISK ASSESSMENT TOOL

OVERALL RISK EVENT: Ferguson Volunteer Bushfire Brigade Shed Extension

RISK THEME PROFILE:

4 - Document Management Processes

15 - Purchasing and Supply

RISK ASSESSMENT CONTEXT: Strategic

		PRIOR TO TR	EATMENT OR CO	ONTROL		AFTER TREA	TEMENT OR COM	NTROL
CONSEQUENCE CATEGORY	RISK EVENT	CONSEQUENCE	LIKELIHOOD	INHERENT RISK RATING	RISK ACTION PLAN (Treatment or controls proposed)	CONSEQUENCE	LIKELIHOOD	RESIDUAL RISK RATING
HEALTH	New extension will be connected to existing septic system and adding infrastructure must comply with health standards	Minor (2)	Possible (3)	Moderate (5 - 11)	Health officer has reviewed risk and as the numbers of occupants/users are not increasing, the risk is very low and existing septic system is confirmed as adequate	Insignificant (1)	Unlikely (2)	Low (1 - 4)
FINANCIAL IMPACT	Overall project cost exceeds budget.	Moderate (3)	Unlikely (2)	Moderate (5 - 11)	Project has been split into two phases to facilitate budget shortfall	Minor (2)	Unlikely (2)	Low (1 - 4)
SERVICE INTERRUPTION	While works are being undertaken, the existing building and services can possibly be interrupted and building be unusable when water tank is moved and existing services are disconnected	Moderate (3)	Likely (4)	High (12 - 19)	The volunteer bushfire personnel to be briefed and advised to have alternative option in place in case of fire or emergency call-outs during this time. Trucks to be filled from Upper Ferguson and Wellington Mills VBFB during this time.	Minor (2)	Unlikely (2)	Low (1 - 4)
LEGAL AND COMPLIANCE	Procurement non-compliance when procuring goods and/or services, possible litigation. Record keeping non-compliance.	Moderate (3)	Unlikely (2)	Moderate (5 - 11)	This project has been to the market multiple times and scope adjusted. Ensure record keeping is in place on official shire platforms for auditing purposes.	Insignificant (1)	Unlikely (2)	Low (1 - 4)
REPUTATIONAL	The Council could be seen in a negative light if this project does not proceed as Shire has been out to market three times for pricing. There is an	Major (4)	Likely (4)	High (12 - 19)	Receiving additional funds for earthworks and negotiating with the successful contractor to amend pricing will ensure project continuation.	Minor (2)	Unlikely (2)	Low (1 - 4)

		PRIOR TO TR	EATMENT OR CO	ONTROL		AFTER TREATEMENT OR CONTROL		
CONSEQUENCE CATEGORY	RISK EVENT	CONSEQUENCE	LIKELIHOOD	INHERENT RISK RATING	RISK ACTION PLAN (Treatment or controls proposed)	CONSEQUENCE	LIKELIHOOD	RESIDUAL RISK RATING
	expectation by DFES and the Ferguson VBFB that the Shire will find a workable solution for this project to proceed.							
ENVIRONMENT	No risk event identified for this category.	Not Required - No Risk Identified	N/A	N/A	Not required.	Not required.	Not required.	Not required.
PROPERTY	No risk event identified for this category.	Not Required - No Risk Identified	N/A	N/A	Not required.	Not required.	Not required.	Not required.